

**PLANNING COMMISSION MEETING  
TUESDAY, JANUARY 9, 2024 6:00 P.M.  
Council Chambers  
40 W MAIN ST, NEWARK, OH 43055**

**AGENDA**

- 1. CALL TO ORDER**
- 2. APPROVAL OF MINUTES FOR THE November 14, 2023 PLANNING COMMISSION MEETING**

**OLD BUSINESS**

There is none this meeting

**NEW BUSINESS**

- 3. SITE PLAN REVIEW PC 23-42 - New Taco Bell Restaurant, 105 Dayton Road**  
**Application Number :** PC-23-42  
**Owner:** MRG Ohio Propco LLC, 10600 Shadow Wood Dr, Houston, Tx 77043  
**Applicant:** Anthony Wong - Kimley Horn and Associates Inc., 7965 N. High St., Columbus, Oh. 43235
- 4. SITE PLAN REVIEW PC 23-41 Site Plan Review for new multi-family apartment complex, Vista Residential Partners, West Main St., north of Builders Drive**  
**Application Number :** PC-23-41  
**Owner:** Frederick William Englefield IV, PO Box 1187, Newark, Ohio 43058  
**Applicant:** Vista Residential Partners - Scott Hartley, 2964 Peachtree Rd., Atlanta, Ga. 30305  
**Architect:** Archall-Jonathan Grubb, 49 East 3<sup>rd</sup> Ave., Columbus, Oh. 43201  
**Engineer:** ADR - Brian Wood, 88 West Church St., Newark, Oh. 43055

**MISCELLANEOUS – ADMINISTRATIVE APPROVALS**

There are none this meeting

**THE NEXT SCHEDULED PLANNING COMMISSION MEETING WILL BE HELD ON TUESDAY, FEBRUARY 13, 2024, 6:00 P.M. THE DEADLINE FOR AGENDA ITEM SUBMITTAL IS TUESDAY JANUARY 16, 2024 4:30 P.M.**



## CITY OF NEWARK PLANNING COMMISSION STAFF REPORT

### JANUARY 9, 2024 PLANNING COMMISSION MEETING

#### Application:

1. **PC FILE 23-42: SITE PLAN FOR NEW TACO BELL RESTAURANT, 105 DAYTON ROAD**

#### Staff Report & Recommendations:

##### **Overview:**

The applicant intends to build a 2,154 SF new restaurant building with drive-thru service.

The Site Plan Review Committee submitted comments on 1/4/2024 regarding this application. Reviewers included:

- Mark Mauter, Development Director
- Brandon Metzger, Fire Chief
- Aaron Holman, NFD
- Erik McKee, Police Chief
- Craig Riley, Deputy Police Chief
- Brandon Fox, Utilities Superintendent
- Adam Bernard, Utilities Engineer
- Lindsey Brighton, Stormwater Utility
- Nick Shultz, Street and Traffic Engineer
- Don Hiltner, Senior Engineer
- Brian Morehead, City Engineer
- George Carter, Zoning Inspector

##### A. Zoning District:

This site is zoned General Commercial District (GC); the proposed use is a permitted use.

**Flood Zones:** This structure is not located in the 100-year Floodplain Area.

##### B. Safety Division Review:

The Police Division and Fire Divisions have no issues with the proposed structure.

##### C. Height Restrictions:

There are no height restrictions in the GC District.

##### D. Lot Area & Setbacks:

Parcel is approximately 76,666 S.F. +/-, with 2.8% building coverage, which meets the lot setback and area requirements of 35% maximum coverage. The building meets the setback requirements of the code.

##### E. Off-Street Parking & Loading:

Code requires 22 parking spaces for the new development on this site, and 22 new spaces are specifically proposed.



## CITY OF NEWARK

### PLANNING COMMISSION STAFF REPORT

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**F. Corner Lots:**

There are no structures proposed in the corner lot areas.

**G. Landscaping, Buffering & Greenspace:**

The landscaping requirement consists of 2,154 +/- SF of green space (Lawn) and greater than 540 SF of the green space area shall be ground cover (planting areas) as required by the Zoning Code. In addition, 3 trees are required on the entire site. No landscaping plan has been submitted for review, but is required to verify the required landscaping areas.

**H. Public & Private Roadways – Access Management:**

A new driveway approach is planned with this structure, and the access will be via the 60' ingress/egress easement to the south of the site, rather than a new approach onto Dayton Road, which would have required an additional turn lane on Dayton Road. This driveway could also serve any future development on the west half of the parcel. From an engineering standpoint, we prefer this driveway approach and recommended it to the designer.

**I. Site Signage:**

No additional signage has been submitted with the proposal. The exterior building elevations are shown with building signs shown, but these need to be submitted separately for a zoning permit for the site signage.

**J. Traffic Control / Street / Right-of-Way Issues:**

No comments on these items.

**K. Engineering / Utilities:**

Engineering and Water staff will be reviewing the detailed water, sanitary and stormwater management plans; these have not yet been submitted for review. Engineering will follow up for compliance prior to construction.

There have been no stormwater management calculations submitted, and this will be submitted and reviewed prior to zoning approval. There is no public storm sewer nearby, so the design manages the stormwater on this site.

**L. Other Standards/Regulations**

A site lighting plan has been submitted with this proposal, and the lighting levels look to be acceptable. There is no residential property nearby this development that could be impacted.

No other comments at this time.



## CITY OF NEWARK PLANNING COMMISSION STAFF REPORT

### **Recommendations:**

Staff recommends conditional approval of the Site Plan in order to grant Zoning approval of the site, provided the following issues are addressed:

1. Landscaping plan submitted with more detail, calculations and measurements.
2. Any of the remaining issues listed above will be addressed on the final construction plans. Compliance with City's Stormwater Management requirements.

If approved by Planning Commission, the zoning certificate will not be granted until the above conditions are resolved / met.

### **Planning Commission Action on Recommendation:**

- Approved As Submitted  
 Approved As Noted, With Contingencies  
 Denied

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Planning Director

Date

PITTSBURG, CINCINNATI, CHICAGO  
 & ST. LOUIS RAILROAD  
 TRACK MAP VOL. 1, PAGE 113


MRG OHIO PROPCO LLC  
 DAYTON RD  
 PID: 055-163596-00.00  
 0.51 AC

MRG OHIO PROPCO LLC  
 DAYTON RD  
 PID: 055-282834-00.00  
 1.76 AC

NICK ANY K SUCCESSION TRUSTEE  
 77 DAYTON ROAD  
 PID: 055-282750-04.00  
 4.33 AC

LICKING COUNTY DEVELOPMENT COMPANY, LTD.  
 55-57 DAYTON ROAD  
 PID: 055-282750-00.00  
 2.42 AC

PRIVATE DRIVE

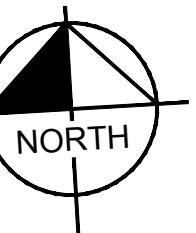

GRAPHIC SCALE IN FEET  
 0 10 20 40

#### LEGEND

- EXISTING PROPERTY BOUNDARY
- EXISTING PROPERTY LINE
- EXISTING RIGHT-OF-WAY
- EXISTING EASEMENT
- EXISTING MANHOLE
- EXISTING OVERHEAD ELECTRIC LINE
- EXISTING POWER POLE
- EXISTING LIGHT POLE
- EXISTING FIRE HYDRANT
- PROPOSED BUILDING
- PROPOSED FACE-OF-CURB
- PROPOSED BACK-OF-CURB
- PROPOSED SIDEWALK
- PROPOSED LIGHT DUTY ASPHALT PAVEMENT
- PROPOSED STANDARD DUTY ASPHALT PAVEMENT
- PROPOSED HEAVY DUTY CONCRETE PAVEMENT
- PROPOSED SIDEWALK
- PROPOSED LANDSCAPE AREA
- PROPOSED LIGHT POLE
- PROPOSED SIGN
- NUMBER OF PARKING STALLS

**Kimley»Horn**

**SITE PLAN**

**TACO BELL**  
 CITY OF NEWARK  
 LICKING COUNTY, OHIO

SUBMITTAL DATE:  
 12/18/2023

KHA PROJECT NO.  
 190164010

SHEET NUMBER

1

#### SITE PLAN KEY NOTES

- 6" CONCRETE CURB (PER CMS ITEM 609)
- CONCRETE SIDEWALK (PER CMS ITEM 608)
- CONNECT TO EXISTING PAVEMENT, SIDEWALK, CURB, TYP.
- LIGHT DUTY ASPHALT PAVEMENT
- STANDARD DUTY ASPHALT PAVEMENT
- HEAVY DUTY CONCRETE PAVEMENT
- FLUSH CURB (PER CMS ITEM 609)
- ACCESSIBLE RAMP (PER CMS ITEM 608)
- 4" WIDE PAINTED SOLID LINE, WHITE, TYP. (PER CMS ITEM 641)
- TRANSVERSE/DIAGONAL LINE, WHITE, TYP. (PER CMS ITEM 641)
- ACCESSIBLE PAVEMENT MARKINGS, TYP. (PER CMS ITEM 641)
- VAN ADA PARKING STALL SIGNAGE
- WHEEL STOP
- MENU BOARD
- DRIVE THRU CANOPY
- REFUSE ENCLOSURE
- PAVEMENT MARKING, WHITE (PER CMS ITEM 641)
- BOLLARD
- CLEARANCE BAR
- SITE LIGHT POLE
- TRANSFORMER PAD
- 24" STOP BAR (PER CMS ITEM 641)
- STOP SIGN
- DO NOT ENTER SIGN
- PYLON (FREESTANDING) SIGN, 20 FEET AFG

#### SITE PLAN NOTES

1. ALL CURB RADII TO BE 3-FEET UNLESS OTHERWISE NOTED.
2. ALL DIMENSIONS ARE TO THE FACE-OF-CURB UNLESS OTHERWISE NOTED.
3. BUILDING DIMENSIONS ARE TO THE OUTSIDE FACE OF BUILDING UNLESS OTHERWISE NOTED.

#### SITE UTILITY SUMMARY

- ELECTRIC: AEP HAS FACILITIES AVAILABLE ON THE WEST SIDE OF DAYTON ROAD WITH CAPACITY TO SERVE THIS DEVELOPMENT.
- GAS: THE ENERGY COOPERATIVE HAS FACILITIES AVAILABLE ON THE WEST SIDE OF DAYTON ROAD WITH CAPACITY TO SERVE THE DEVELOPMENT.
- TELEPHONE: SPECTRUM HAS FACILITIES AVAILABLE WITH CAPACITY TO SERVE THE DEVELOPMENT.
- SANITARY: THE CITY OF NEWARK HAS A 12" PUBLIC SANITARY MAIN ALONG THE EAST AND SOUTH SIDES OF THE PROPERTY WITH CAPACITY TO SERVE THIS DEVELOPMENT. AN EXISTING 6" SERVICE STUB (NWE) WAS PROVIDED ON THE MAIN FOR USE BY THIS SITE.
- STORM SEWER: A BIORETENTION OR DRY BASIN WILL BE UTILIZED TO MANAGE THE STORMWATER ON-SITE AND DISCHARGE TO THE EXISTING DITCH ALONG THE WEST SIDE OF DAYTON ROAD IN COMPLIANCE WITH CITY REGULATIONS.
- WATER: THE CITY OF NEWARK HAS A 16" PUBLIC WATER MAIN ALONG THE WEST SIDE OF DAYTON ROAD WITH CAPACITY TO SERVE THIS DEVELOPMENT. A 2" DOMESTIC WATER SERVICE WILL BE PROVIDED TO THE BUILDING. METERING AND BACKFLOW PREVENTION WILL COMPLY WITH CITY REGULATIONS.

**FRONT ELEVATION** 1/4" = 1'-0"

**1**

**ZONING  
SUBMITTAL**

	DATE	REMARKS
1	12/15/2023	ZONING

CONTRACT DATE:  
BUILDING TYPE: END. MED 40

WM UPLOAD DATE: 06/30/2022

BRAND DESIGNER:

SITE NUMBER:

STORE NUMBER:  
PA/P/M: RA

DRAWN BY.: EB

JOB NO.:  
**ENDEAVOR 2.0**

ADDRESS TBD DAYTON RD  
NEWARK, OH



**ENDEAVOR 2.0  
EXTERIOR  
ELEVATIONS**

**A4.0**

PLOT DATE: 12/14/2023 9:22 AM

	CONTACT INFORMATION	ALUMINUM TRIM PROFILES (ALTERNATE SOURCE)
-OSS	SEE C / A 7.2	DESCRIPTION ITEM ID - MANUFACTURER
SS		SURROUND J CHANNEL TRIM T2 - FRY REGLET JMS - TAMLYN
-OSS		SURROUND VERTICAL TRIM V2 - FRY REGLET W516RV - TAMLYN
SS	SEE C / A 7.2	VENT SCREEN VST38 - TAMLYN
SS	SEE C / A 7.2	SURROUND HORIZONTAL TRIM W2 - TAMLYN
	SEE C / A 7.2	SURROUND DRAINAGE FLASHING XWF - TAMLYN
	SEE C / A 7.2	SURROUND OUTSIDE CORNER TRIM OC9 - FRY REGLET XOCR516 - TAMLYN
COATING	SEE C / A 7.2	SURROUND INSIDE CORNER TRIM IC1 or IC21 - FRY REGLET XIC516 - TAMLYN

**EXTERIOR FINISH SCHEDULE**

**D**

## **REAR ELEVATION**

1

# ZONING SUBMITTAL

	DATE	REMARKS
1	12/15/2023	ZONING

**CONTRACT DATE:**

BUILDING TYPE: END. MED 40

W UPLOAD DATE: 06/30/2022

## BRAND DESIGNER:

ITE NUMBER:

STORE NUMBER:

A/PM: RA

DRAWN BY.: EB  
SP-105


JOB NO..

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# ENDEAVOR 2.0

# ENDEAVOR 2.0

## EXTERIOR ELEVATIONS

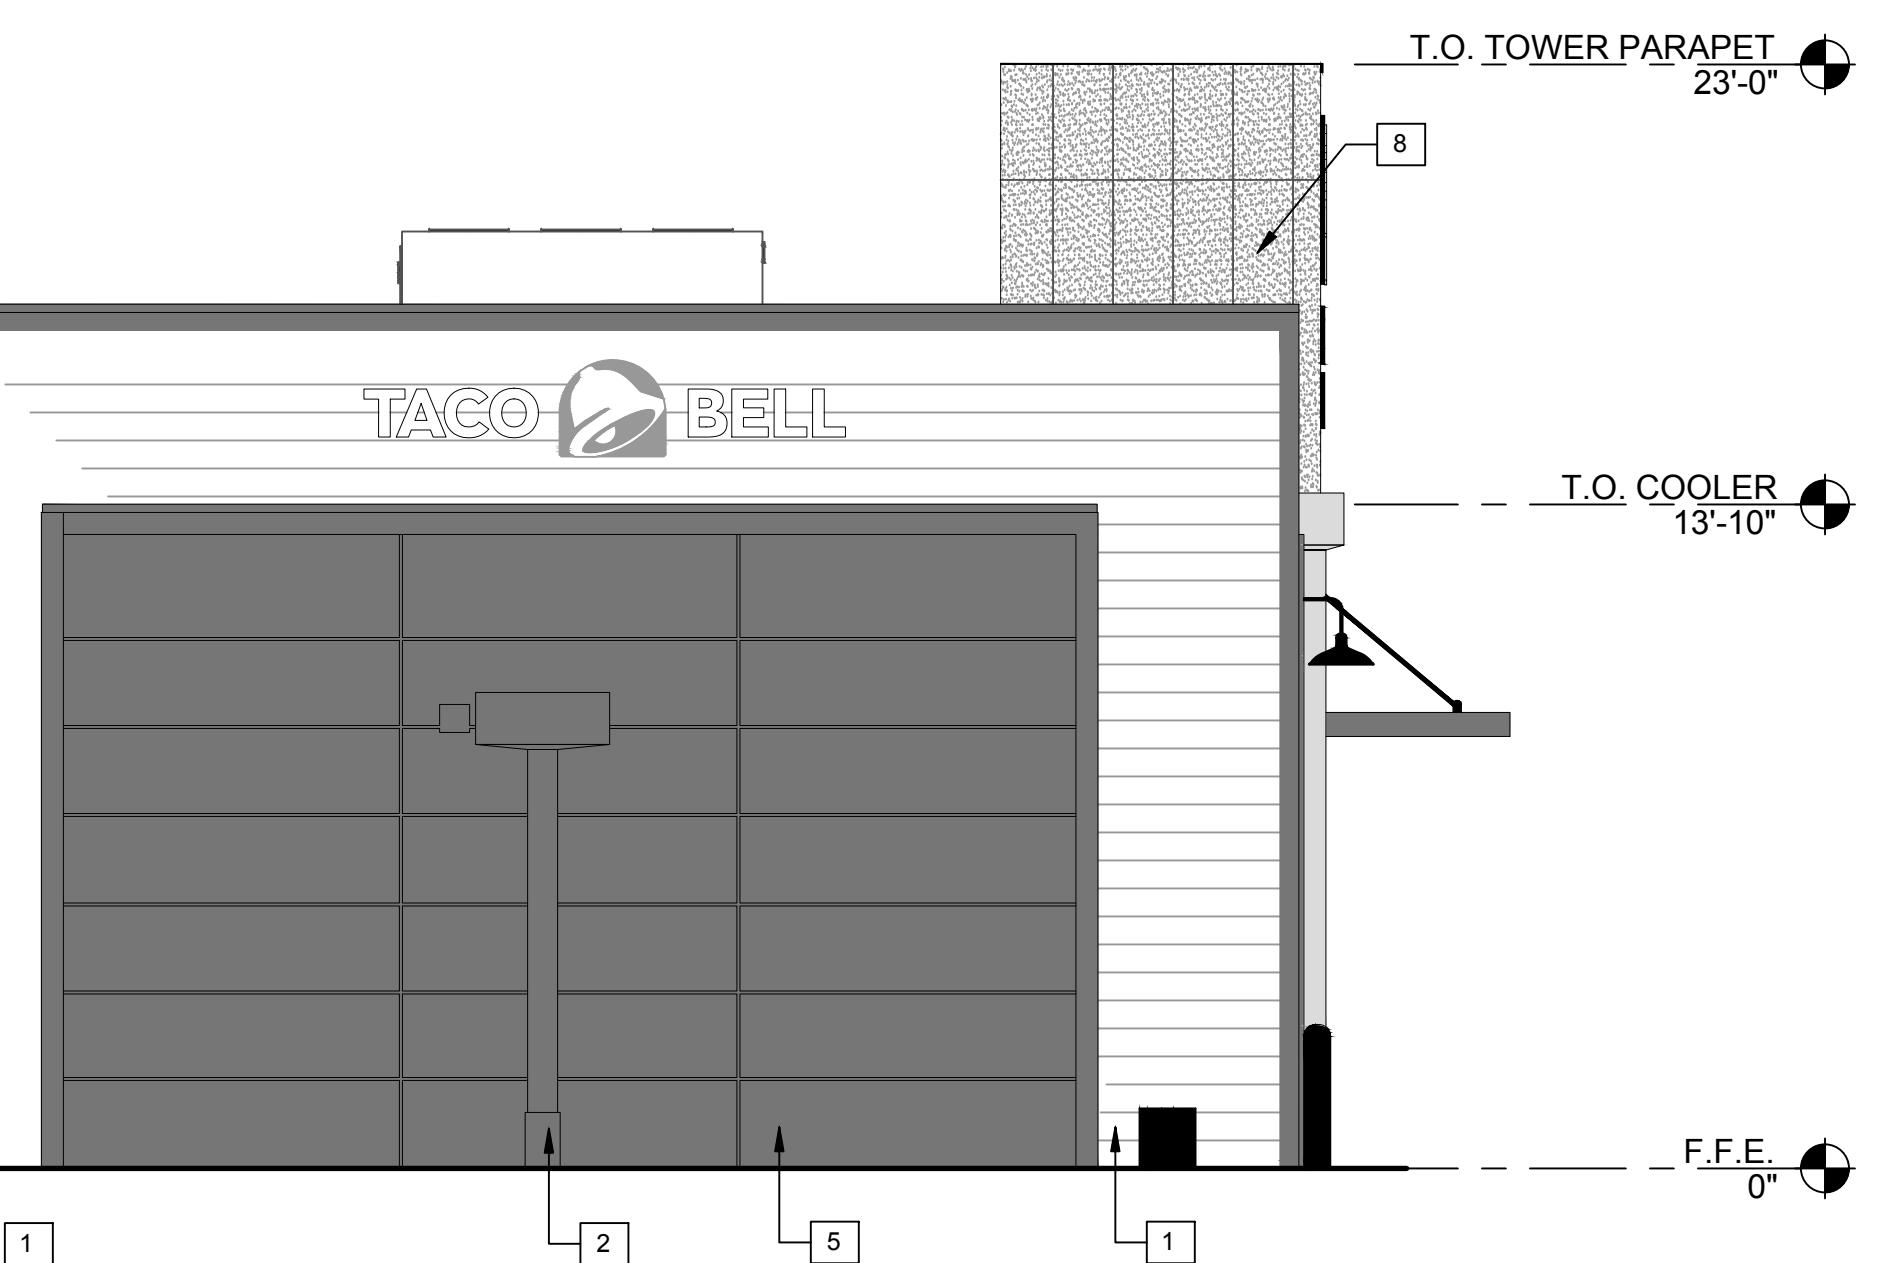

# A4.1

**REAR ELEVATION** 1/4" = 1'-0"

3

LOT DATE: 12/14/2023 9:22 AM

REFERENCE  
DOCUMENTS ONLY

NOT FOR  
CONSTRUCTION

TACO BELL NEWARK, OH  
STREET ADDRESS  
CITY, STATE, ZIP

Issue Record:  
12.13.2023 PRELIMINARY

Revisions:

Drawn: Checked:  
SS RS

Project No.:  
MRG001

Contents:  
SITE PLAN  
ELECTRICAL SHELL


E100

ABBREVIATIONS	
[A] EXISTING TO BE ABANDONED	INCD INCANDESCENT
[D] EXISTING TO BE DEMOLISHED	KVA KILOVOLT AMPERE
[E] EXISTING TO REMAIN	KW KILOWATT
[F] FUTURE	LIG LIGHTING OR LIGHT
[R] EXISTING TO BE RELOCATED	LRA LOCKED ROTOR AMPS
A AMPERE	MCA MAXIMUM CURRENT AMPACITY
AC ALTERNATING CURRENT OR AIR CONDITIONER	MCB MAIN CIRCUIT BREAKER
AFF ABOVE FINISHED FLOOR	MCC MOTOR CONTROL CENTER
AFG ABOVE FINISHED GRADE	MDP MAIN DISTRIBUTION PANEL
AIC AMPS INTERRUPTING CAPACITY	MLO MAIN LUGS ONLY
ANNC ANNUNCIATOR	MOPC MAXIMUM OVERCURRENT PROTECTION
AWG AMERICAN WIRE GAUGE	MSB MAIN SWITCHBOARD
BPS BOLTED PRESSURE SWITCH	MH METAL HALIDE
C CONDUIT	MTS MANUAL TRANSFER SWITCH
CB CIRCUIT BREAKER	NAC NOTIFICATION APPLIANCE CIRCUIT
CCTV CLOSED CIRCUIT TELEVISION	NC NORMALLY CLOSED
CKT CIRCUIT	NO NORMALLY OPEN
CM CONSTRUCTION MANAGER	NF NON-FUSED
DC DIRECT CURRENT	OCC OCCUPANCY
DP DISTRIBUTION PANELBOARD	PA PUBLIC ADDRESS
DTT DOUBLE TWIN TUBE	PB PULL BOX OR PUSH BUTTON
EB ELECTRONIC BALLAST	PVC POLYVINYL CHLORIDE (PLASTIC PIPE)
EC ELECTRICAL CONTRACTOR	PWR POWER
EM EMERGENCY	RECEPT RECEPTACLE
EMT ELECTRICAL METAL TUBING	STP SHIELDED, TWISTED PAIR
EWC ELECTRIC WATER COOLER	TC TIME CLOCK
FA FIRE ALARM	TRT TRIPLE TUBE
FLA FULL LOAD AMPS	TYP TYPICAL
G GROUND	UNO UNLESS NOTED OTHERWISE
GC GENERAL TRADES CONTRACTOR	UTP UNSHIELDED, TWISTED PAIR
GFCI GROUND FAULT CIRCUIT INTERRUPTER	V VOLT
GEN GENERATOR	W WATT
HOA HAND-OFF-AUTOMATIC	WAP WIRELESS ACCESS POINT
HP HORSEPOWER	WH WATTHOUR
HPC HIGH PRESSURE CONTACT SWITCH	WP WEATHERPROOF, NEMA 3R UNO
Hz HERTZ	XFMR TRANSFORMER
IG ISOLATED GROUND	Z IMPEDANCE
IMC INTERMEDIATE METAL CONDUIT	Φ PHASE

LIGHTING LEGEND		ELECTRICAL LEGEND	
TAG	DESCRIPTION	DETAIL	DESCRIPTION
♦ WALL SCONCE		♦ DUPLEX RECEPTACLE - WITH WEATHERPROOF COVER & GFCI	
✖ EXIT/EMERGENCY LIGHT W/ BATTERY PACK AND DUAL HEADS		▲ BRANCH CIRCUIT HOME-RUN WITH CIRCUIT NUMBER	
✖ EXIT/EMERGENCY LIGHT WITH BATTERY PACK		○ JUNCTION BOX	
✖ EXIT LIGHT (SURFACE MOUNTED)		□ DISCONNECT - NON FUSED	
✖ EXIT LIGHT (CEILING MOUNTED)		☒ UTILITY METER	
✖ REMOTE EMERGENCY HEADS		■ ELECTRICAL PANEL	
✖ EMERGENCY BATTERY PACK AND DUAL HEADS			

GENERAL NOTES:	
A.	ALL WORK TO COMPLY TO ALL STATE, LOCAL, NEC, & NFPA CODES.
B.	ELECTRICAL CONTRACTOR TO VISIT THE SITE PRIOR TO SUBMITTING A BID & INCLUDE IN THEIR BID ANY ITEMS NECESSARY FOR A COMPLETE & OPERATIONAL SYSTEM.
C.	DRAWINGS ARE SCHEMATIC IN NATURE. ELECTRICAL CONTRACTOR IS TO ADD ANY ITEMS THAT ARE REQUIRED FOR A COMPLETE & OPERATIONAL SYSTEM IN THEIR PROPOSAL.
D.	ELECTRICAL CONTRACTOR IS TO COORDINATE THEIR INSTALLATION WITH THE OTHER TRADES. IF A CONFLICT OCCURS AND IT IS DUE TO THE ELECTRICAL CONTRACTOR'S LACK OF COORDINATION, ALL WORK INVOLVED IN RESOLVING THE CONFLICT WILL BE AT THE EXPENSE OF THE ELECTRICAL CONTRACTOR.
E.	ELECTRICAL CONTRACTOR TO PAY ALL FEES AND PERMITS.
F.	SEE ARCHITECTURAL DRAWINGS FOR PATIO CONDUIT DETAIL. COORDINATE PRIOR TO ROUGH-IN.
G.	ANY MC CABLE MUST BE RUN IN WALL. ALL CONDUIT OUTSIDE OF WALL TO BE EMT.
H.	CANOPY LIGHTING CONDUIT SHALL BE RUN IN MC CABLE.
I.	NO LIGHTING SUBSTITUTIONS.

CODED NOTES: #	
1.	PROVIDE PARKING AREA LIGHT PER SCHEDULE. REFER TO POLE BASE DETAIL ON SHEET E400 FOR FURTHER INFORMATION. PROVIDE CONDUIT TO LINE VOLTAGE JB. COORDINATE FINAL LOCATIONS WITH CIVIL SITE PLAN AND POINT-BY-POINT PLAN PRIOR TO CONSTRUCTION.

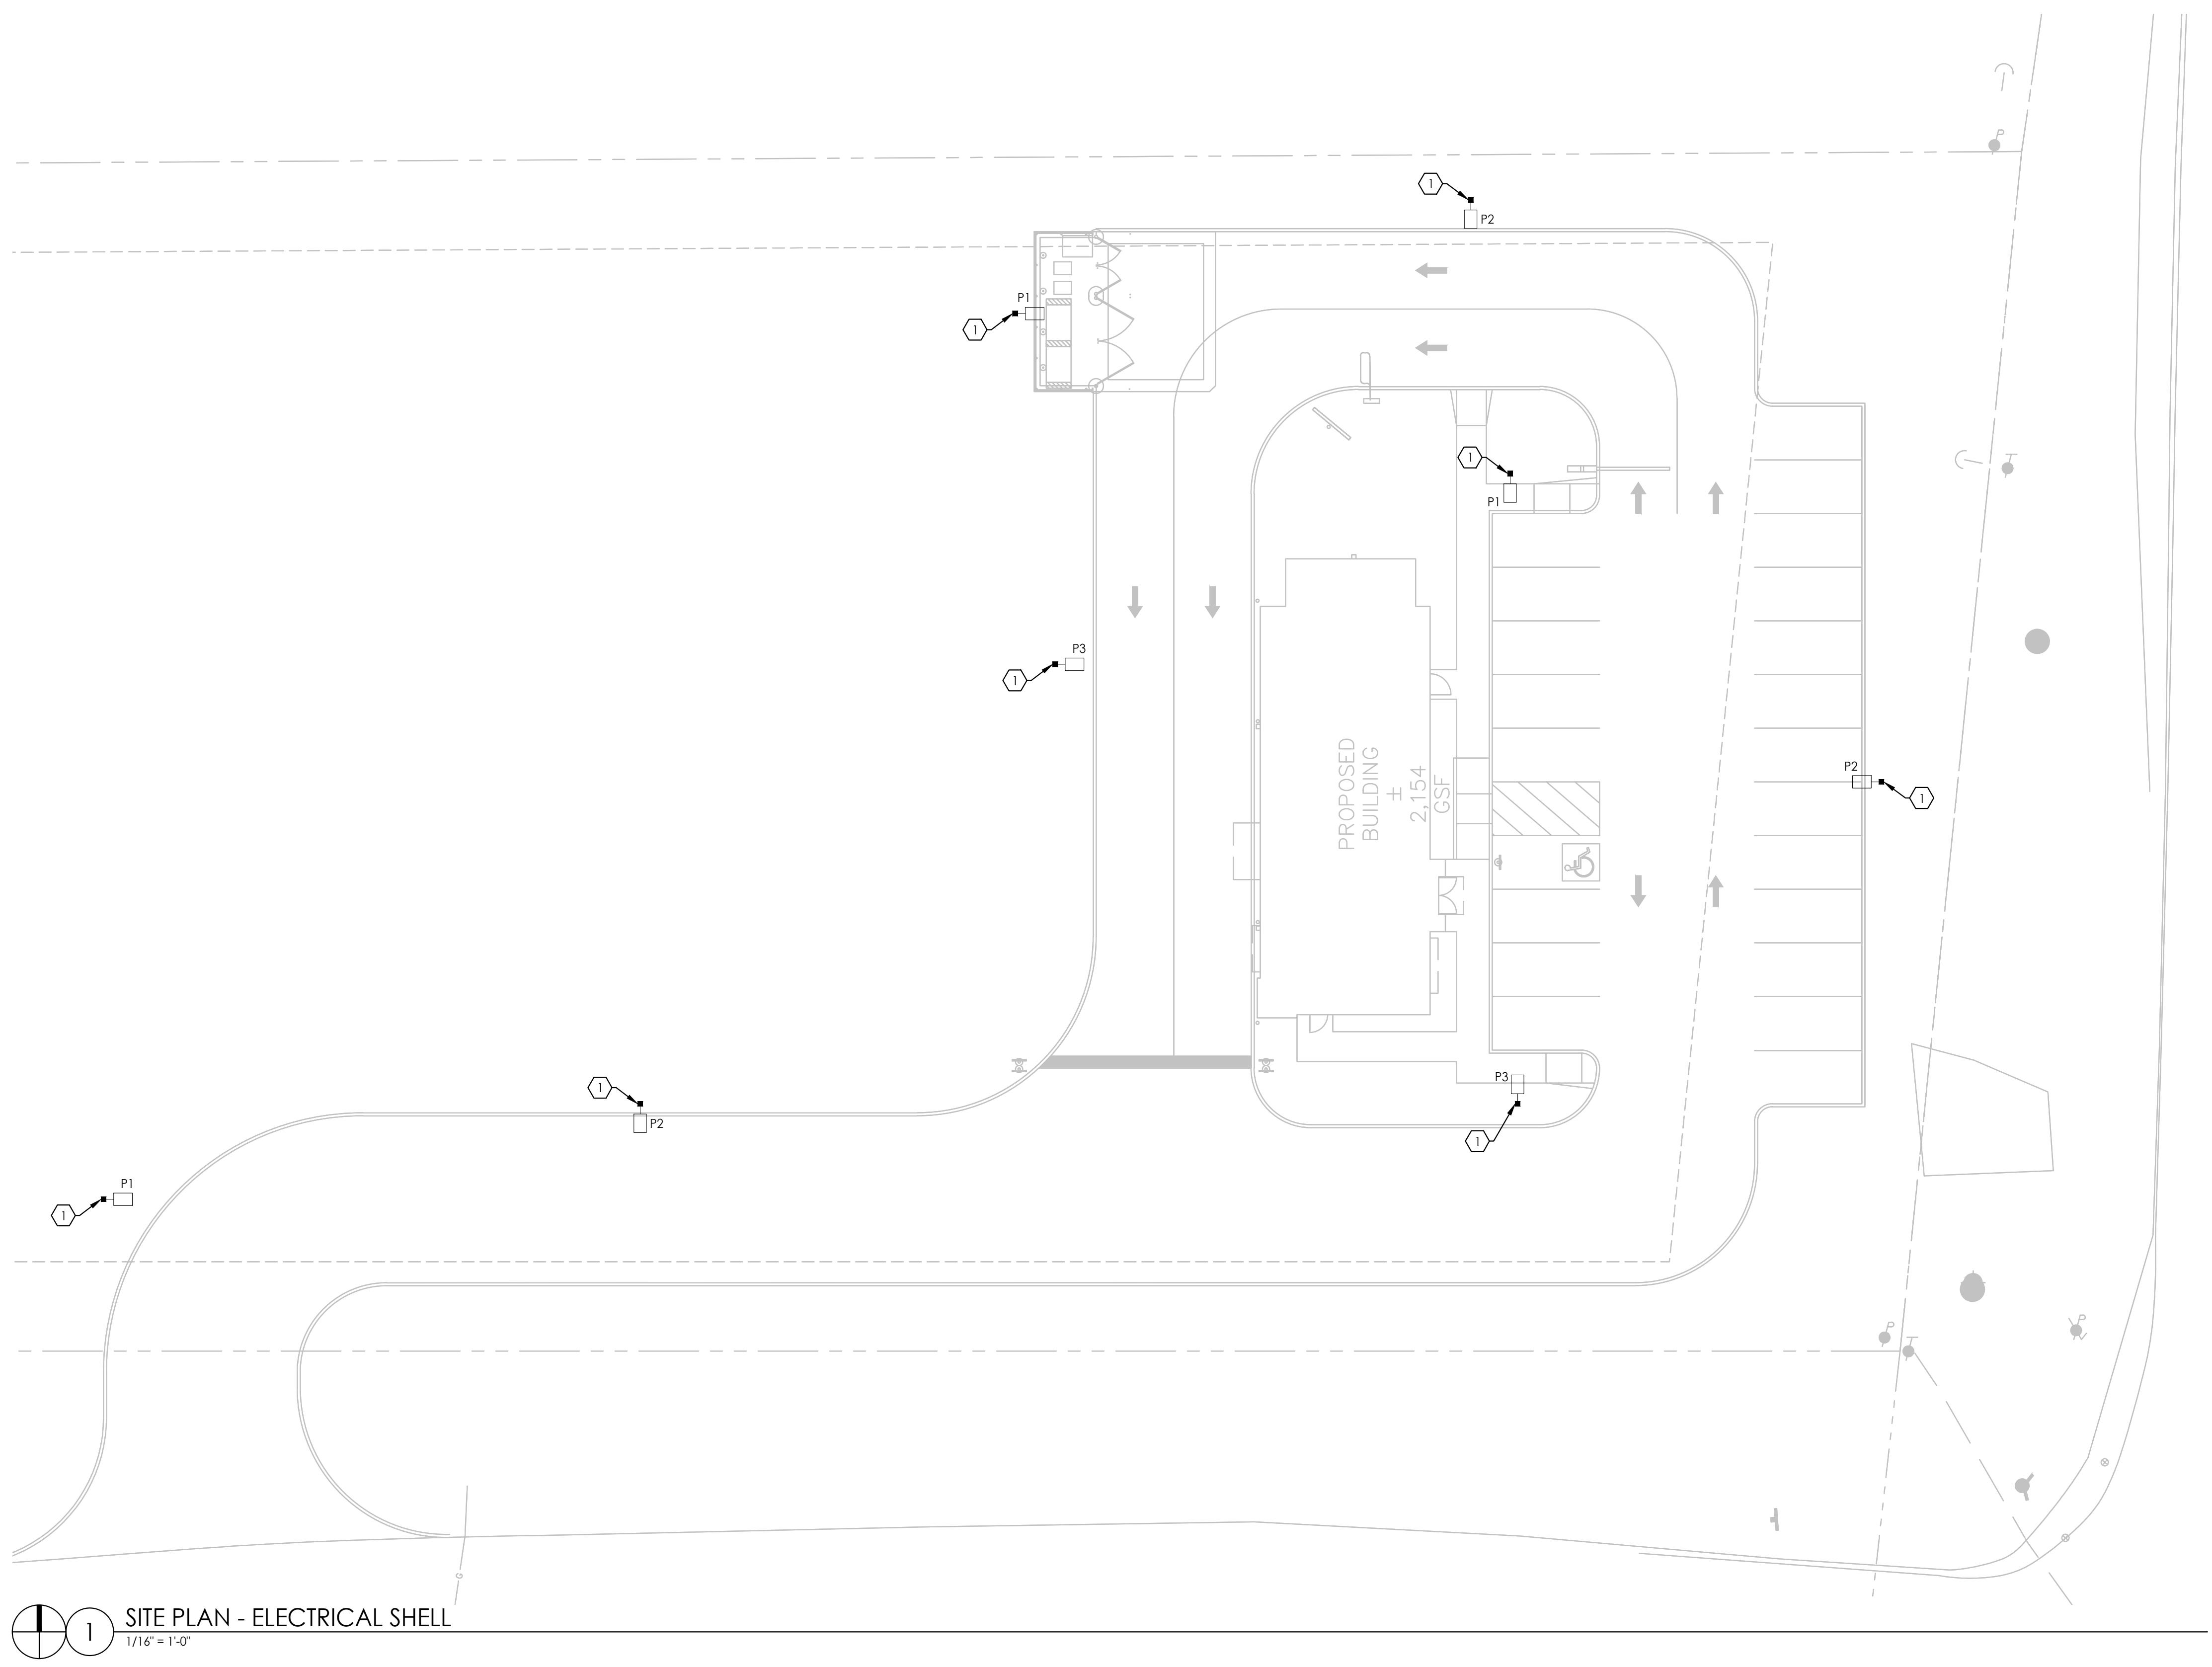

## SHEET NOTE:


POINT-BY-POINT PLAN IS DIAGRAMMATIC IN NATURE AND SHOWN FOR REFERENCE PURPOSES ONLY. FIXTURES ALONG PROPERTY LINES TO HAVE HOUSE-SIDE SHIELDS TO ENSURE FULL CUT OFF AT PROPERTY LINE. LIGHTING LEVELS ALONG PROPERTY LINE TO BE 0.0 FC PER TENANT AND/OR LOCAL AHJ REQUIREMENTS. COORDINATE WITH MANUFACTURER PRIOR TO BID.

## REFERENCE DOCUMENTS ONLY

**NOT FOR  
CONSTRUCTION**

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GROUP AND MAY NOT BE USED, DUPLICATED,  
OR ALTERED WITHOUT THE WRITTEN CONSENT  
OF THE ENGINEER.

Description	Avg	Max	Min
Soil Zone #1	0.9 fc	2.7 fc	0.0 fc

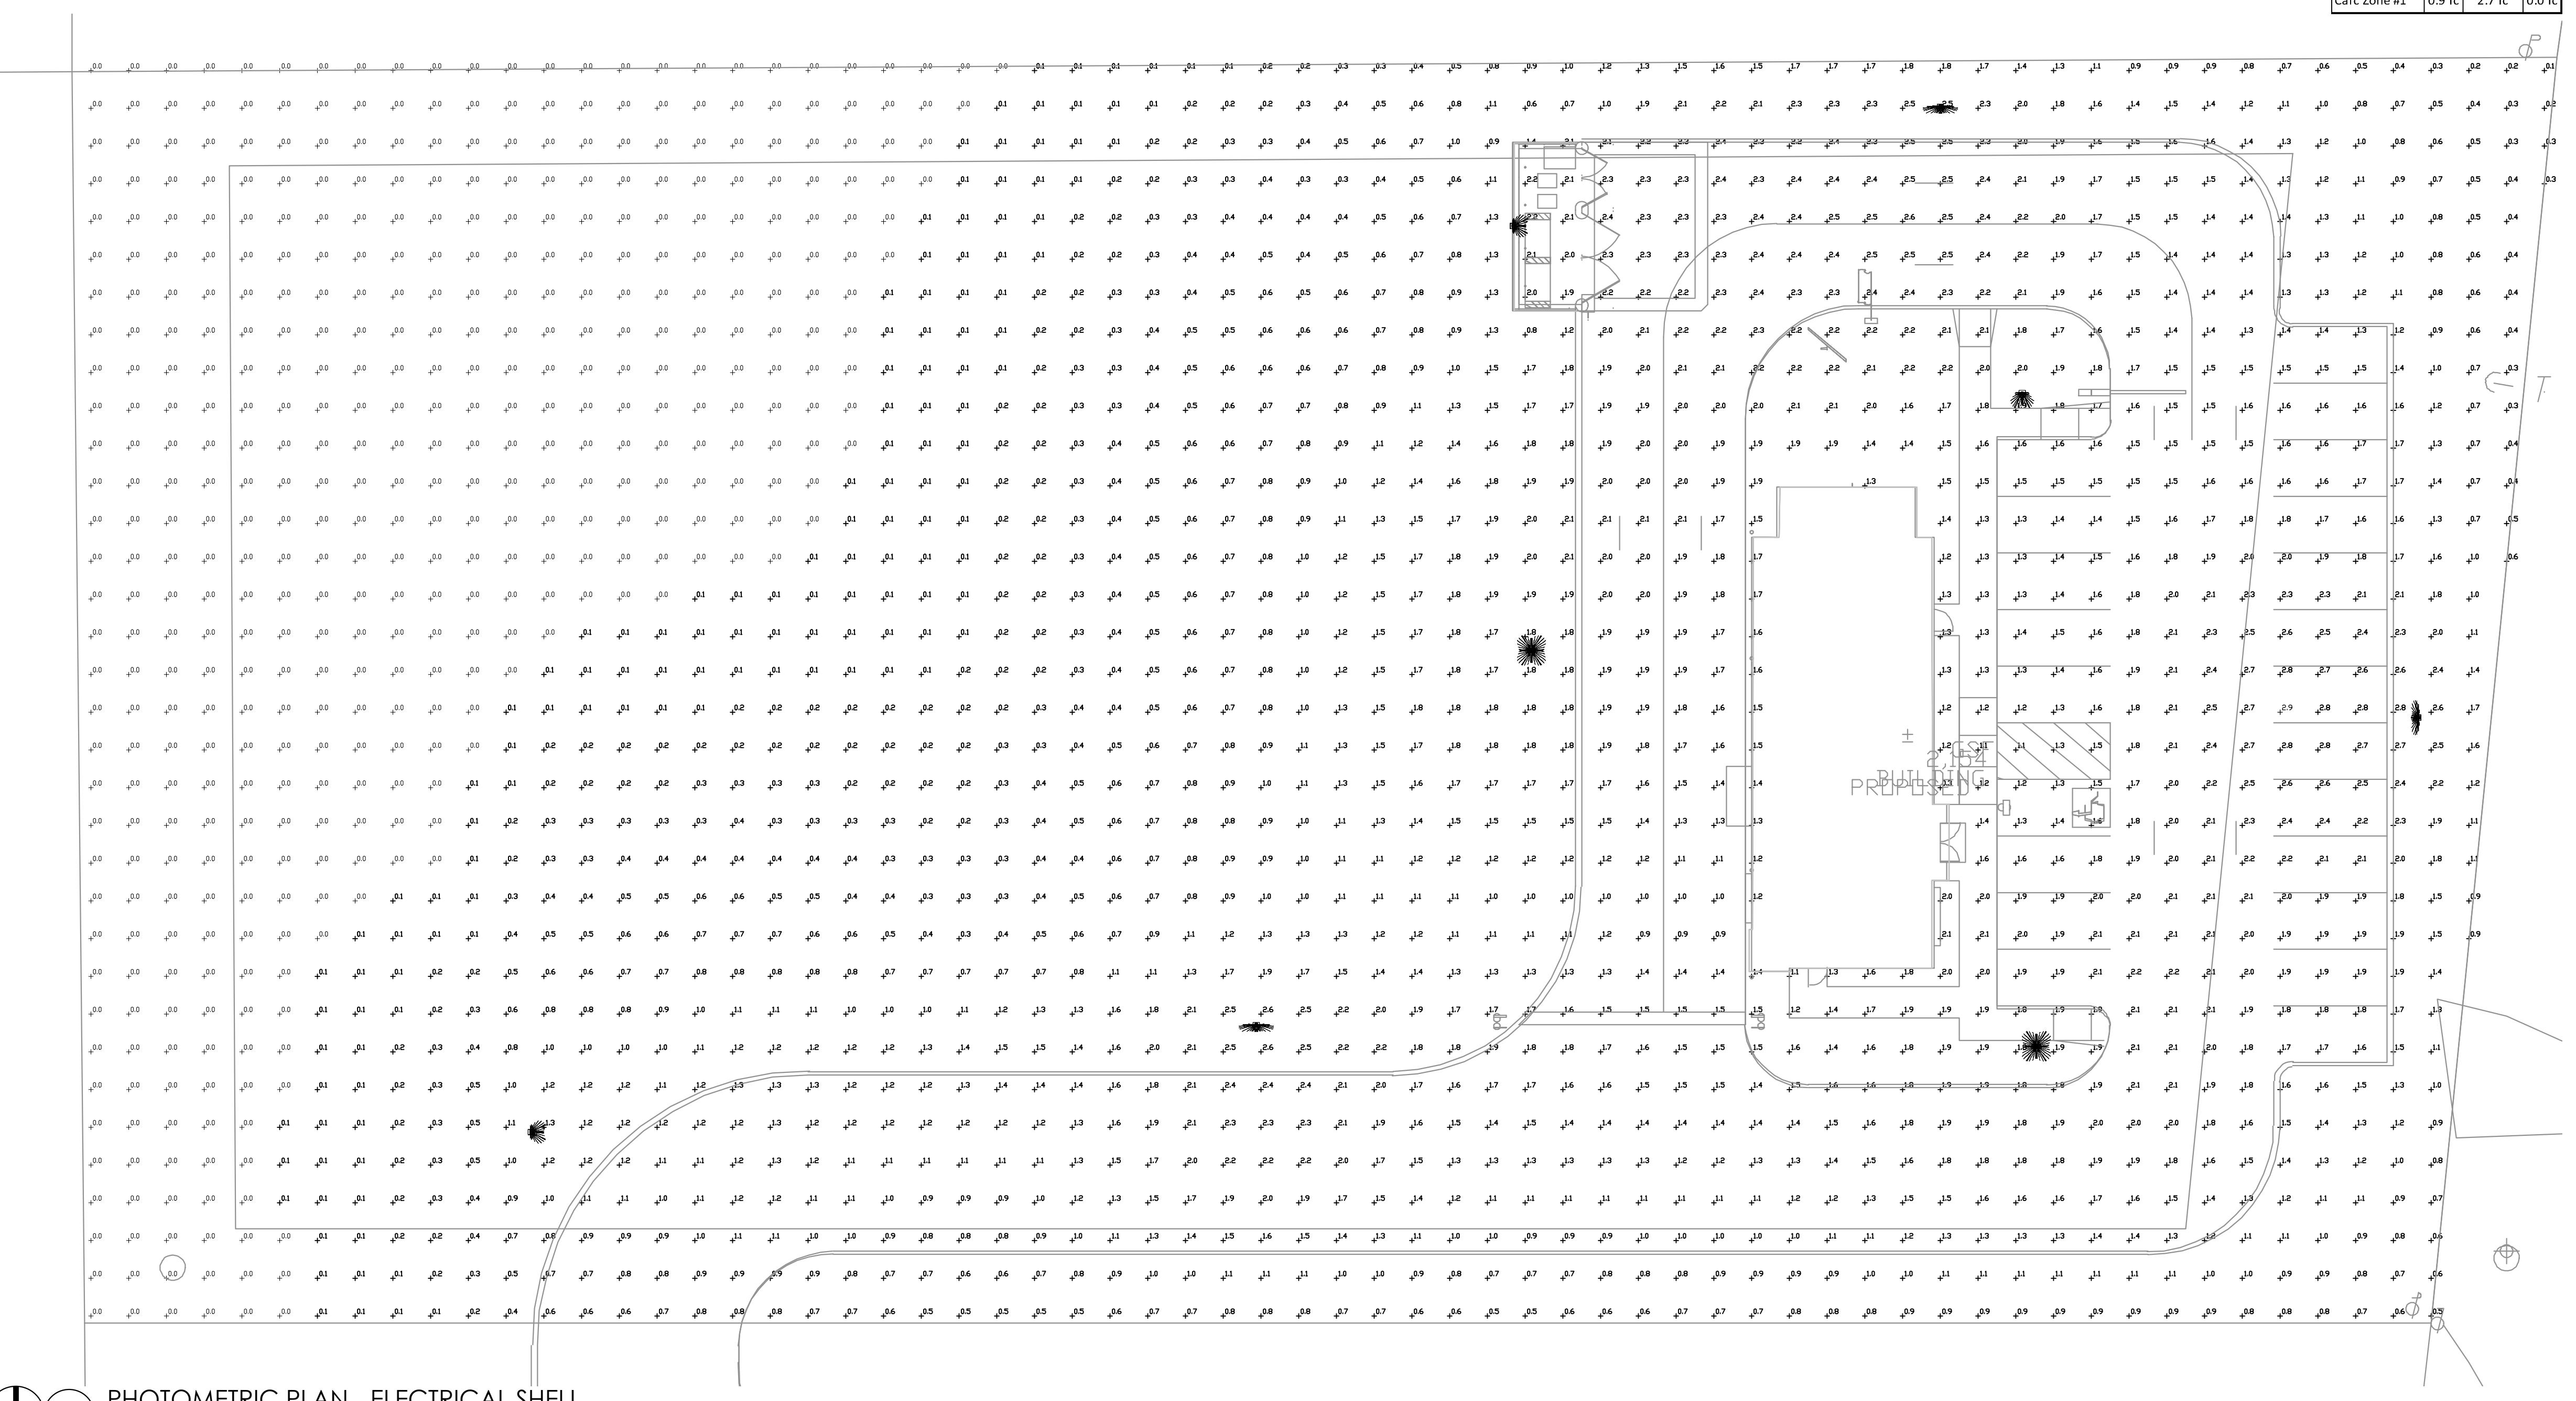

ACO BELL NEWARK, OH  
STREET ADDRESS  
CITY, STATE, ZIP

**Issue Record:**

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Drawn: SS      Checked: RS

**Project No.**

## PHOTOMETRIC PLAN ELECTRICAL SHELL

118


E110

# E110

## LUMINAIRE SCHEDULE SHELL

G	DESCRIPTION	MANUFACTURER	MODEL	LAMP	FINISH/COLOR	COMMENTS	VOLTS	INPUT WATTS
1	SITE LIGHTING	LITHONIA	DSX1 LED P3 40K T2M MVOLT	LED	DARK BRONZE	MOUNT TO 25'-0" SQUARE STEEL POLE. COORDINATE WITH POLE BASE DETAIL THIS SHEET.	120	102
2	SITE LIGHTING	LITHONIA	DSX1 LED P2 40K TFTM MVOLT	LED	DARK BRONZE	MOUNT TO 25'-0" SQUARE STEEL POLE. COORDINATE WITH POLE BASE DETAIL THIS SHEET.	120	70
3	SITE LIGHTING	LITHONIA	DSX1 LED P5 40K T5M MVOLT	LED	DARK BRONZE	MOUNT TO 25'-0" SQUARE STEEL POLE. COORDINATE WITH POLE BASE DETAIL THIS SHEET.	120	138

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OF THE ENGINEER.

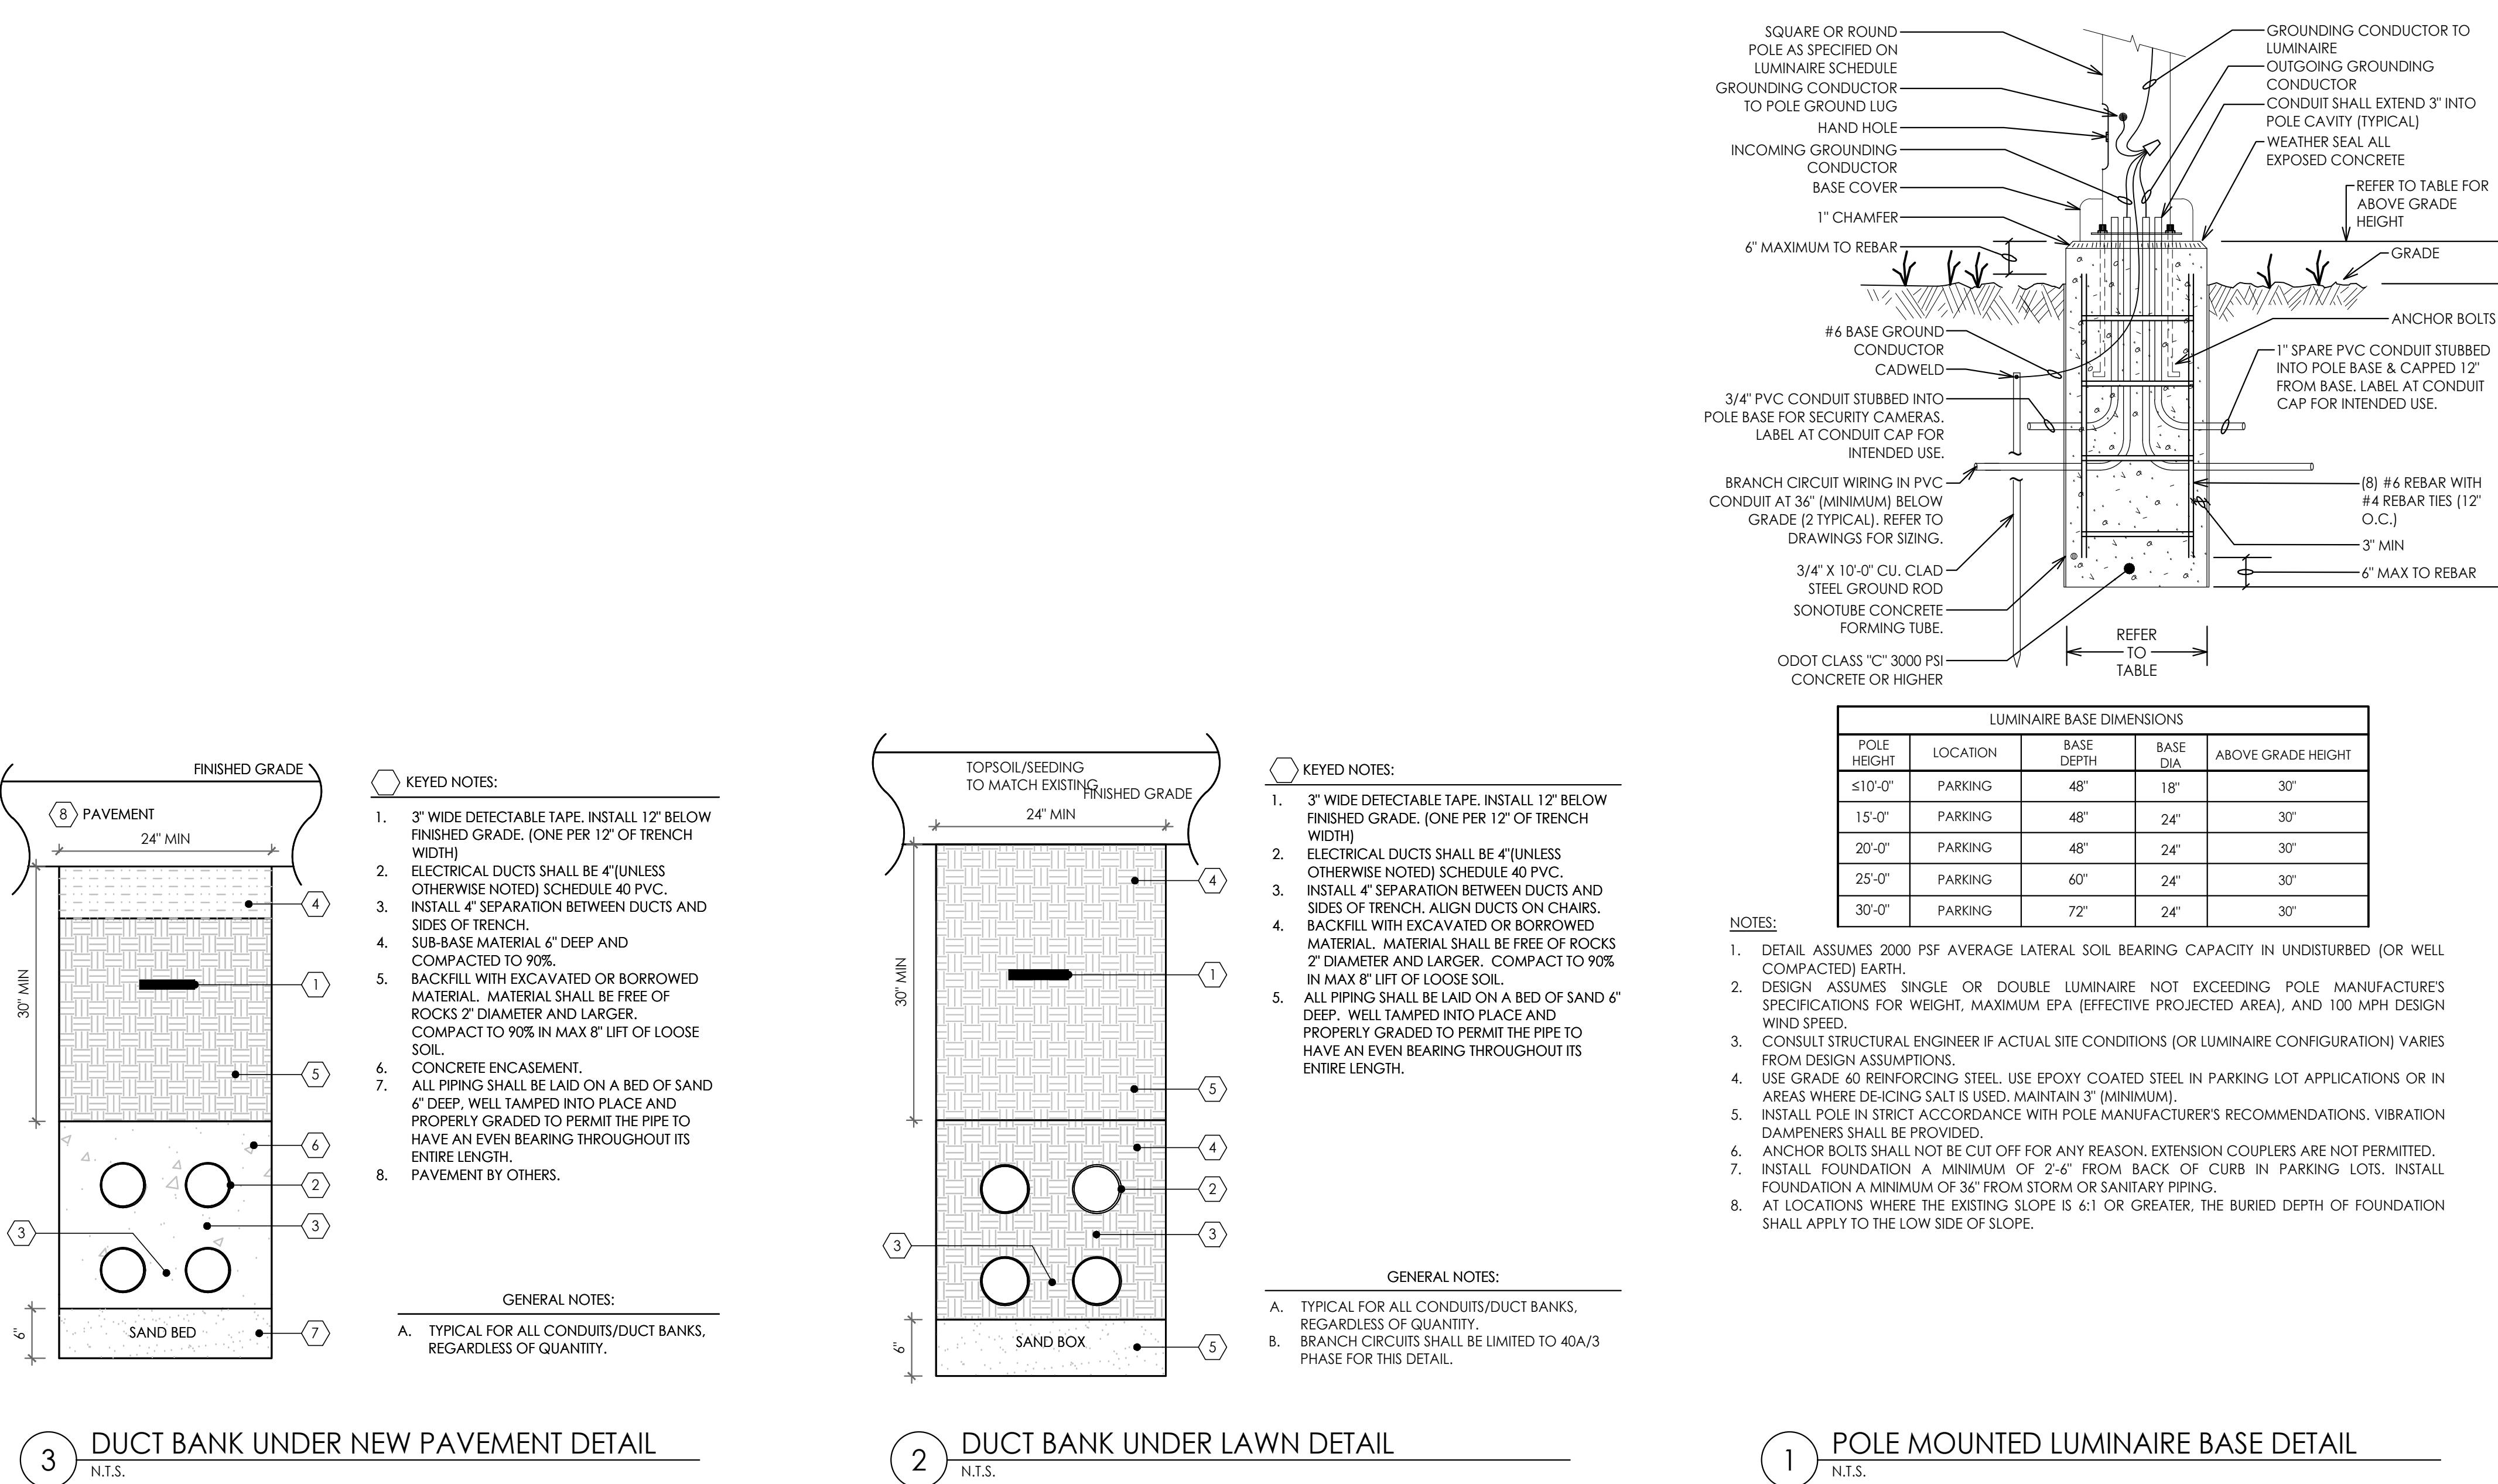

Issue Record:

Revisions:

Drawn: \_\_\_\_\_ Checked: \_\_\_\_\_  
SS DS

**Project No.** \_\_\_\_\_

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## Contents:

# SCHEDULES & DIAGRAMS

E400



**CITY OF NEWARK  
PLANNING COMMISSION STAFF REPORT**

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**JANUARY 9, 2024 PLANNING COMMISSION MEETING**

**Application:**

1. **PC FILE 23-41: SITE PLAN FOR NEW MULTI-FAMILY APARTMENT COMPLEX BY VISTA RESIDENTIAL PARTNERS, WEST MAIN STREET, JUST NORTH OF BUILDERS DRIVE**

**Staff Report & Recommendations:**

**Overview:**

The applicant intends to build a new apartment complex with 9 three and four-story buildings housing 308 units (154 one-bedroom units and 154 two-bedroom units), and 1 clubhouse / pool building.

The Site Plan Review Committee submitted comments on 1/4/2024 regarding this application. Reviewers included:

- Mark Mauter, Development Director
- Brandon Metzger, Fire Chief
- Aaron Holman, NFD
- Erik McKee, Police Chief
- Craig Riley, Deputy Police Chief
- Brandon Fox, Utilities Superintendent
- Adam Bernard, Utilities Engineer
- Lindsey Brighton, Stormwater Utility
- Nick Shultz, Street and Traffic Engineer
- Don Hiltner, Senior Engineer
- Brian Morehead, City Engineer
- George Carter, Zoning Inspector

**A. Zoning District:**

This site is zoned Multi-Family High-Rise Residence District (MFH); the proposed use is a permitted use.

**Flood Zones:** This development is not located in the 100-year Floodplain Area.

**B. Safety Division Review:**

The Police Division has no issues with the proposed development. The Fire Division has had prior discussions with the designer, and provided the access requirements needed for the development.

**C. Height Restrictions:**

There are no height restrictions on any principal building in the MFH District.

**D. Lot Area & Setbacks:**

Parcel is approximately 636,804 S.F. +/-, with 13.7% building coverage, which meets the lot setback and area requirements of 33% maximum coverage. The buildings meet the setback requirements of the code.



## CITY OF NEWARK PLANNING COMMISSION STAFF REPORT

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A lot split and combination is also needed to conform with the proposed site plan. The current proposal is spanning 2 separate parcels with 2 separate owners.

**E. Off-Street Parking & Loading:**

Code requires 693 parking spaces for the new development on this site, and 470 new spaces are specifically proposed (a minimum of 1.5 spaces per unit). This does not meet the requirements, so this would require a variance approval from the Board of Zoning Appeals. We understand this will be a case discussed at the January 25, 2024 BZA meeting.

We have concerns regarding the variance proposal, since it represents a relatively large 32% reduction in the number of required parking spaces. If the variance is not approved, there would be a significant impact to the site plan. Adding up to 223 parking spaces would appear to be extremely challenging with the current site configuration and topography, so we would anticipate that significant revisions would need to be made to the site plan for anything less than full variance approval.

**F. Corner Lots:**

There are no structures proposed in the corner lot areas.

**G. Landscaping, Buffering & Greenspace:**

The landscaping requirement consists of 195,000 +/- SF of green space (Lawn) and greater than 48,750 SF of the green space area shall be ground cover (planting areas) as required by the Zoning Code. In addition, 78 trees are required on the entire site. A landscaping plan has been included for review, and the calculations listed meet the required landscaping areas.

**H. Public & Private Roadways – Access Management:**

A new driveway approach is planned with this development, and to better to comply with access management standards, we prefer to see the driveway aligned with Builders Drive to the south. The designer has pointed out that this alignment would create a sight-distance issue, and is proposing to move the driveway approximately 150' west to resolve this issue. The negative aspect of this proposal is that the minimum driveway spacing requirements are not met. Additional roadway work on West Main Street west of Builders Drive could eliminate the sight-distance issue, but this engineering problem still needs more work to resolve.

**I. Site Signage:**

No additional signage has been submitted with the proposal. The exterior building elevations are shown with the various building layouts. Any other signage will need to be submitted and reviewed separately for a zoning permit.



## CITY OF NEWARK PLANNING COMMISSION STAFF REPORT

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### J. Traffic Control / Street / Right-of-Way Issues:

We have had earlier discussions with the developer regarding our concerns about the increased traffic that this development will generate, and about the City's future plans to improve West Main Street between Coffman Road and Thornwood Drive. This has resulted in the development of a Traffic Impact Study to try to find a resolution to these issues, and recommendations for roadway improvements. The draft study has been submitted, we've provided comments, but the study is not yet final. We hope to coordinate improvements on West Main Street that will be beneficial as more development occurs in that area.

### K. Engineering / Utilities:

Engineering and Water staff will be reviewing the detailed water, sanitary and stormwater management plans; these have not yet been submitted for review. Engineering will follow up for compliance prior to construction.

### L. Other Standards/Regulations

1. This development should include a multi-purpose path connection to the existing path. We would promote a connection through the development and along the east property line to connect with the existing path. We would be glad to investigate / coordinate such an improvement with the T.J. Evans Foundation, as easements may be needed to accomplish this improvement.
  
2. The City Administration may propose to enter into a Development Agreement with the Developer of this site, similar to the agreements that we have done on prior residential developments. There are several outstanding roadway issues that could be addressed in such an agreement, and the City has also discussed an exaction fee to address off-site improvements, as has been negotiated on other recent development projects.

### **Recommendation:**

**At this time, our recommendation is to table the approval of this site plan.** There are still several outstanding issues that need to be resolved before recommending full or conditional approval of this site plan.

If BZA variances are not approved, the site plan will need major revisions to meet the zoning requirements, and will likely need to be revised and resubmitted.

In any case, the following issues need to be addressed, at a minimum:

1. BZA variance for parking space count needs resolved.
2. Lot split / combination is submitted and approved.



## CITY OF NEWARK PLANNING COMMISSION STAFF REPORT

3. Access management – driveway location issue needs resolved
4. Traffic Impact Study completion and roadway improvement agreement
5. Development Agreement, if needed
6. Any of the remaining issues listed above will be addressed on the final construction plans. Compliance with City's Stormwater Management requirements.

When approved by Planning Commission, the zoning certificate will not be granted until the above conditions are resolved / met.


### **Planning Commission Action on Recommendation:**

- Approved As Submitted  
 Approved As Noted, With Contingencies  
 Denied  
 Tabled for future meeting

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Planning Director

Date

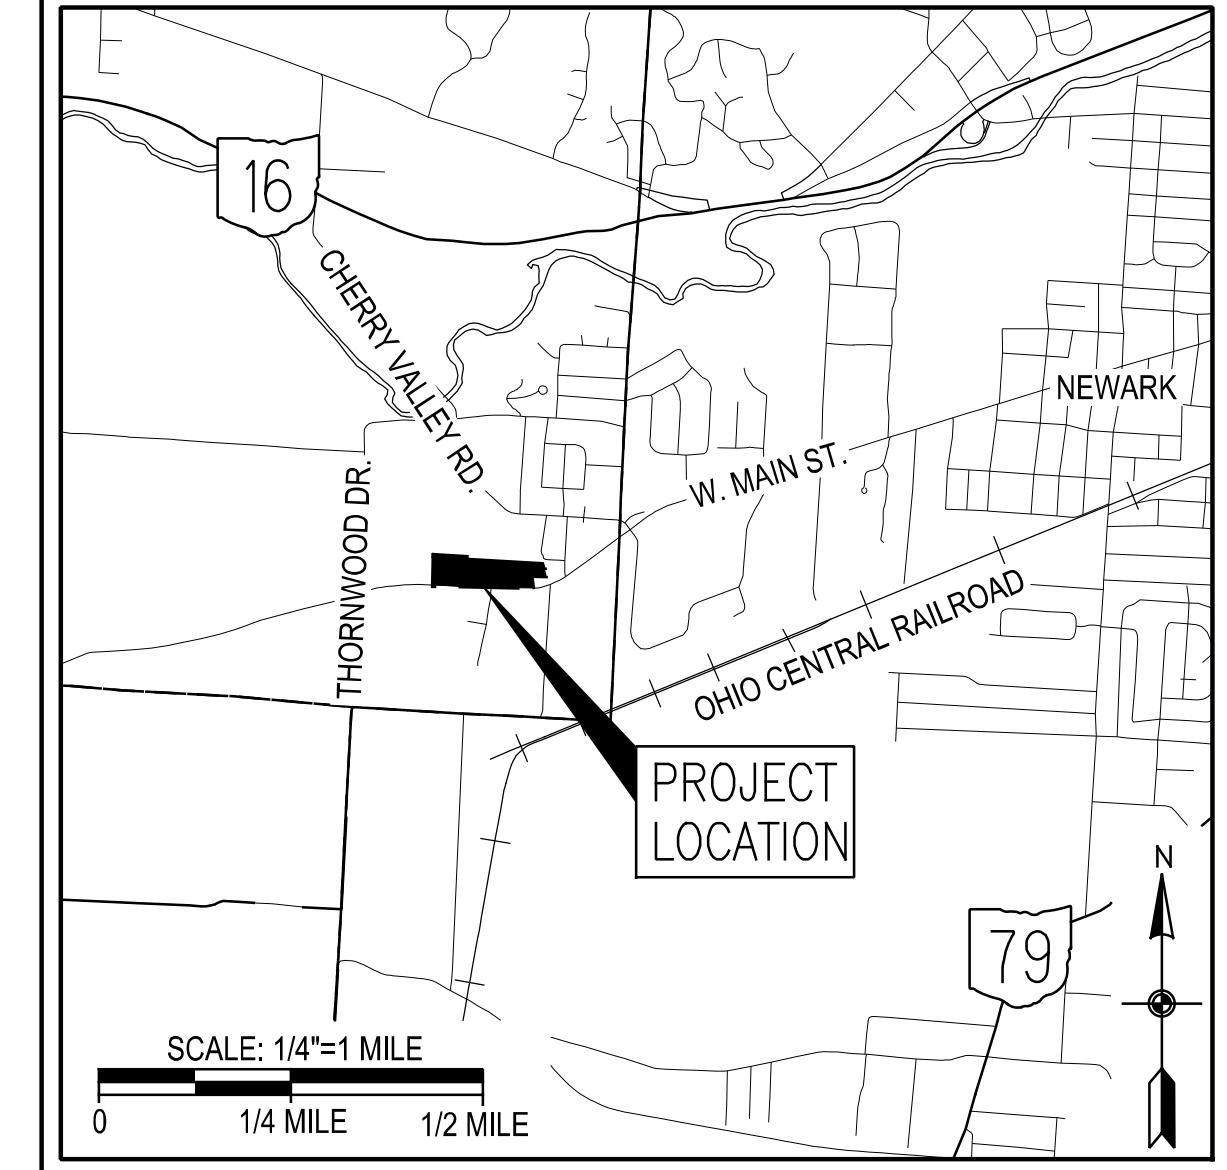

#### SITE INFORMATION:

ADDRESS: W. MAIN STREET  
AUDITORS PAR. NO.: 054-216636-00.000  
PROPOSED SITE AREA: 14.619 Ac.  
PROPOSED BUILDING AREA: 87,200 SQ. FT.  
LOT COVERAGE: 13.7%  
PROPOSED DENSITY: 5,965 SQ. FT./Ac.

#### ZONING INFORMATION:

EXISTING ZONING: MFH - MULTI-FAMILY HIGH-RISE  
EXISTING USE: VACANT LOT  
PROPOSED ZONING: NO CHANGE  
PROPOSED USE: MULTI-FAMILY APARTMENTS  
BUILDING SETBACKS: 35' FRONT  
30' SIDE\*  
50' REAR  
\*FOR BUILDINGS OR STRUCTURES EXCEEDING THIRTY FEET IN HEIGHT, THE SIDE YARD SET BACK SHALL BE ONE FOOT ADDITIONAL FOR EACH FOOT OF HEIGHT EXCEEDING THIRTY FEET

PARKING REQUIRED: 693 TOTAL  
2 SPACES PER UNIT (ONE BEDROOM) x 154 UNITS

PARKING PROVIDED: 470 TOTAL (1.52 SPACES PER UNIT)  
460 STANDARD SPACES  
10 HANDICAP SPACES

#### FLOOD INFORMATION:

THE PROPERTY FALLS WITHIN THE LIMITS OF FLOOD ZONE "X" AS SHOWN ON FIRM MAP No. 39089C0336H DATED MAY 2, 2007.

#### VARIANCES REQUESTED:

VARIANCE FROM SECTION 1290.02, PARKING SPACES REQUIRED (2 SPACES PER ONE BEDROOM UNIT, 2.5 SPACES PER TWO BEDROOM UNIT, 3.5 SPACES PER THREE BEDROOM UNIT). PROPOSED DEVELOPMENT WOULD PROVIDE A MINIMUM OF 1.5 SPACES PER UNIT REGARDLESS OF BEDROOMS.

# TRAILHEAD VISTA SITE COMPLIANCE PLAN SITUATED IN THE CITY OF NEWARK, LICKING COUNTY, OHIO

#### PROJECT DATA


TOTAL AREA:	14.61 ACRES
PROJECT EARTH DISTURB AREA:	12.39 ACRES
ESTIMATED CONTRACTOR (OUTSIDE PROJECT) EARTH DISTURBED AREA:	0.070 ACRES
NOTICE OF INTENT EARTH DISTURBED AREA:	12.46 ACRES
IMPERVIOUS AREA FOR PRE-CONSTRUCTION SITE:	0.040 ACRES
IMPERVIOUS AREA FOR POST-CONSTRUCTION SITE:	7.20 ACRES
RECEIVING WATERS:	CITY OF NEWARK MS4

NOTE: AREAS LISTED FOR PRELIMINARY PURPOSES, NOT FOR CONSTRUCTION.

#### 100 YEAR DETENTION TABLE

DESCRIPTION	VOLUME REQUIRED (C.F.)	ELEVATION REQUIRED	VOLUME PROVIDED (C.F.)	ELEV. FOR PROVIDED VOLUME
DETENTION BASIN	179,670	920.01	210,613	921.00

NOTE: BASIN DATA LISTED FOR PRELIMINARY PURPOSES, NOT FOR CONSTRUCTION.

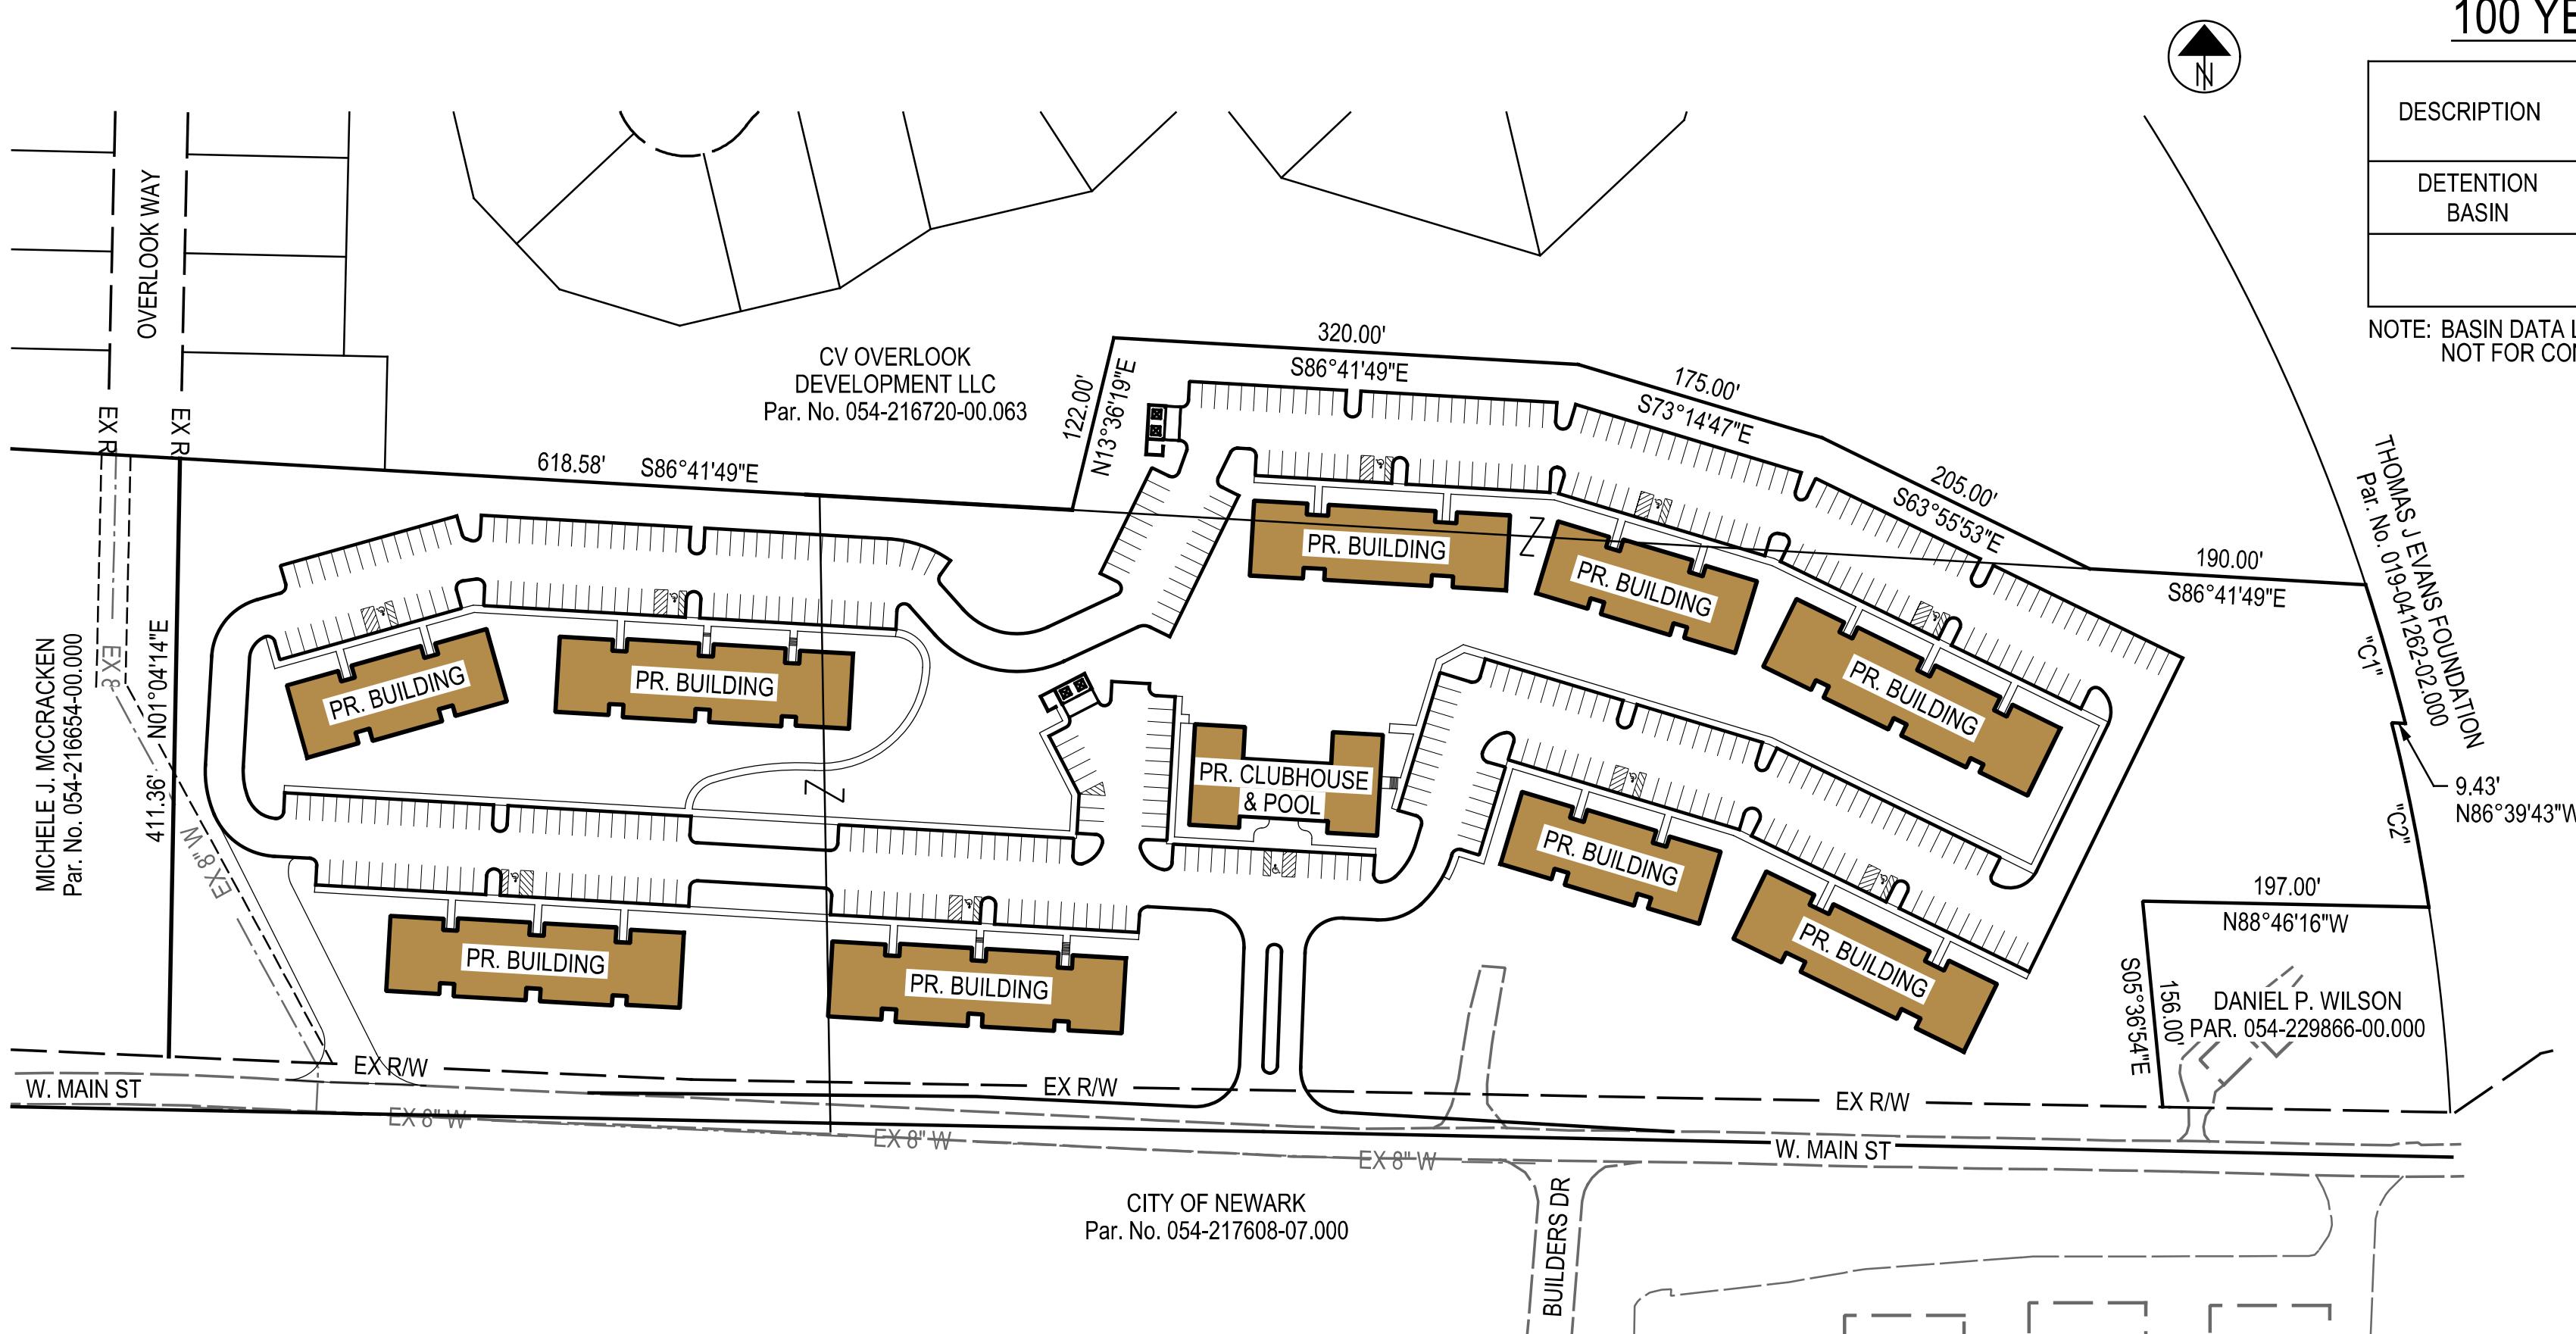

BOUNDARY CURVE TABLE					
No.	DELTA	RADIUS	LENGTH	Ch. BEARING	Ch. DISTANCE
"C1"	04°01'55"	1411.39'	99.32'	S15°59'43"E	99.30'
"C2"	04°44'50"	1402.39'	116.20'	S11°43'13"E	116.16'

#### INDEX OF SHEETS

- |                         |                      |
|-------------------------|----------------------|
| TITLE SHEET             | 1                    |
| SITE PLAN               | 2                    |
| SIGHT DISTANCE EXHIBITS | 3-4                  |
| LANDSCAPING PLAN        | (PROVIDED BY OTHERS) |
| ARCHITECTURAL DETAILS   | (PROVIDED BY OTHERS) |

SIGNATURES BELOW SIGNIFY ONLY CONCURRENCE WITH THE GENERAL PURPOSES AND GENERAL LOCATION OF THE PROJECT. ALL TECHNICAL DETAILS REMAIN THE RESPONSIBILITY OF THE ENGINEER PREPARING THE PLAN.

CITY ENGINEER DATE

CITY SERVICE DIRECTOR DATE

CITY UTILITIES SUPERINTENDENT DATE

CITY STORMWATER COORDINATOR DATE

**ADR**  
ADR & ASSOCIATES, LTD.  
88 West Church Street • Newark, OH 43055 • (740) 345-1921 • (740) 345-4994 (fax)  
www.adrinovation.com

**SITE COMPLIANCE PLAN**  
**TITLE SHEET**

**TRAILHEAD VISTA**  
**CITY OF NEWARK**

DEC. 8, 2023  
JOB #23-062  
1  
4




Newark Office:  
88 West Church Street  
Newark, OH 43055  
(740) 345-1921 (ph)  
(740) 345-4994 (fax)  
www.adrinovation.com

Digitally signed by  
Brian C. Klingenberg  
Date: 2023.12.08  
10:11:54-05'00'

BRIAN C. KLINGENBERG, P.E.  
OHIO PROFESSIONAL ENGINEER #82904




# SITE PLAN

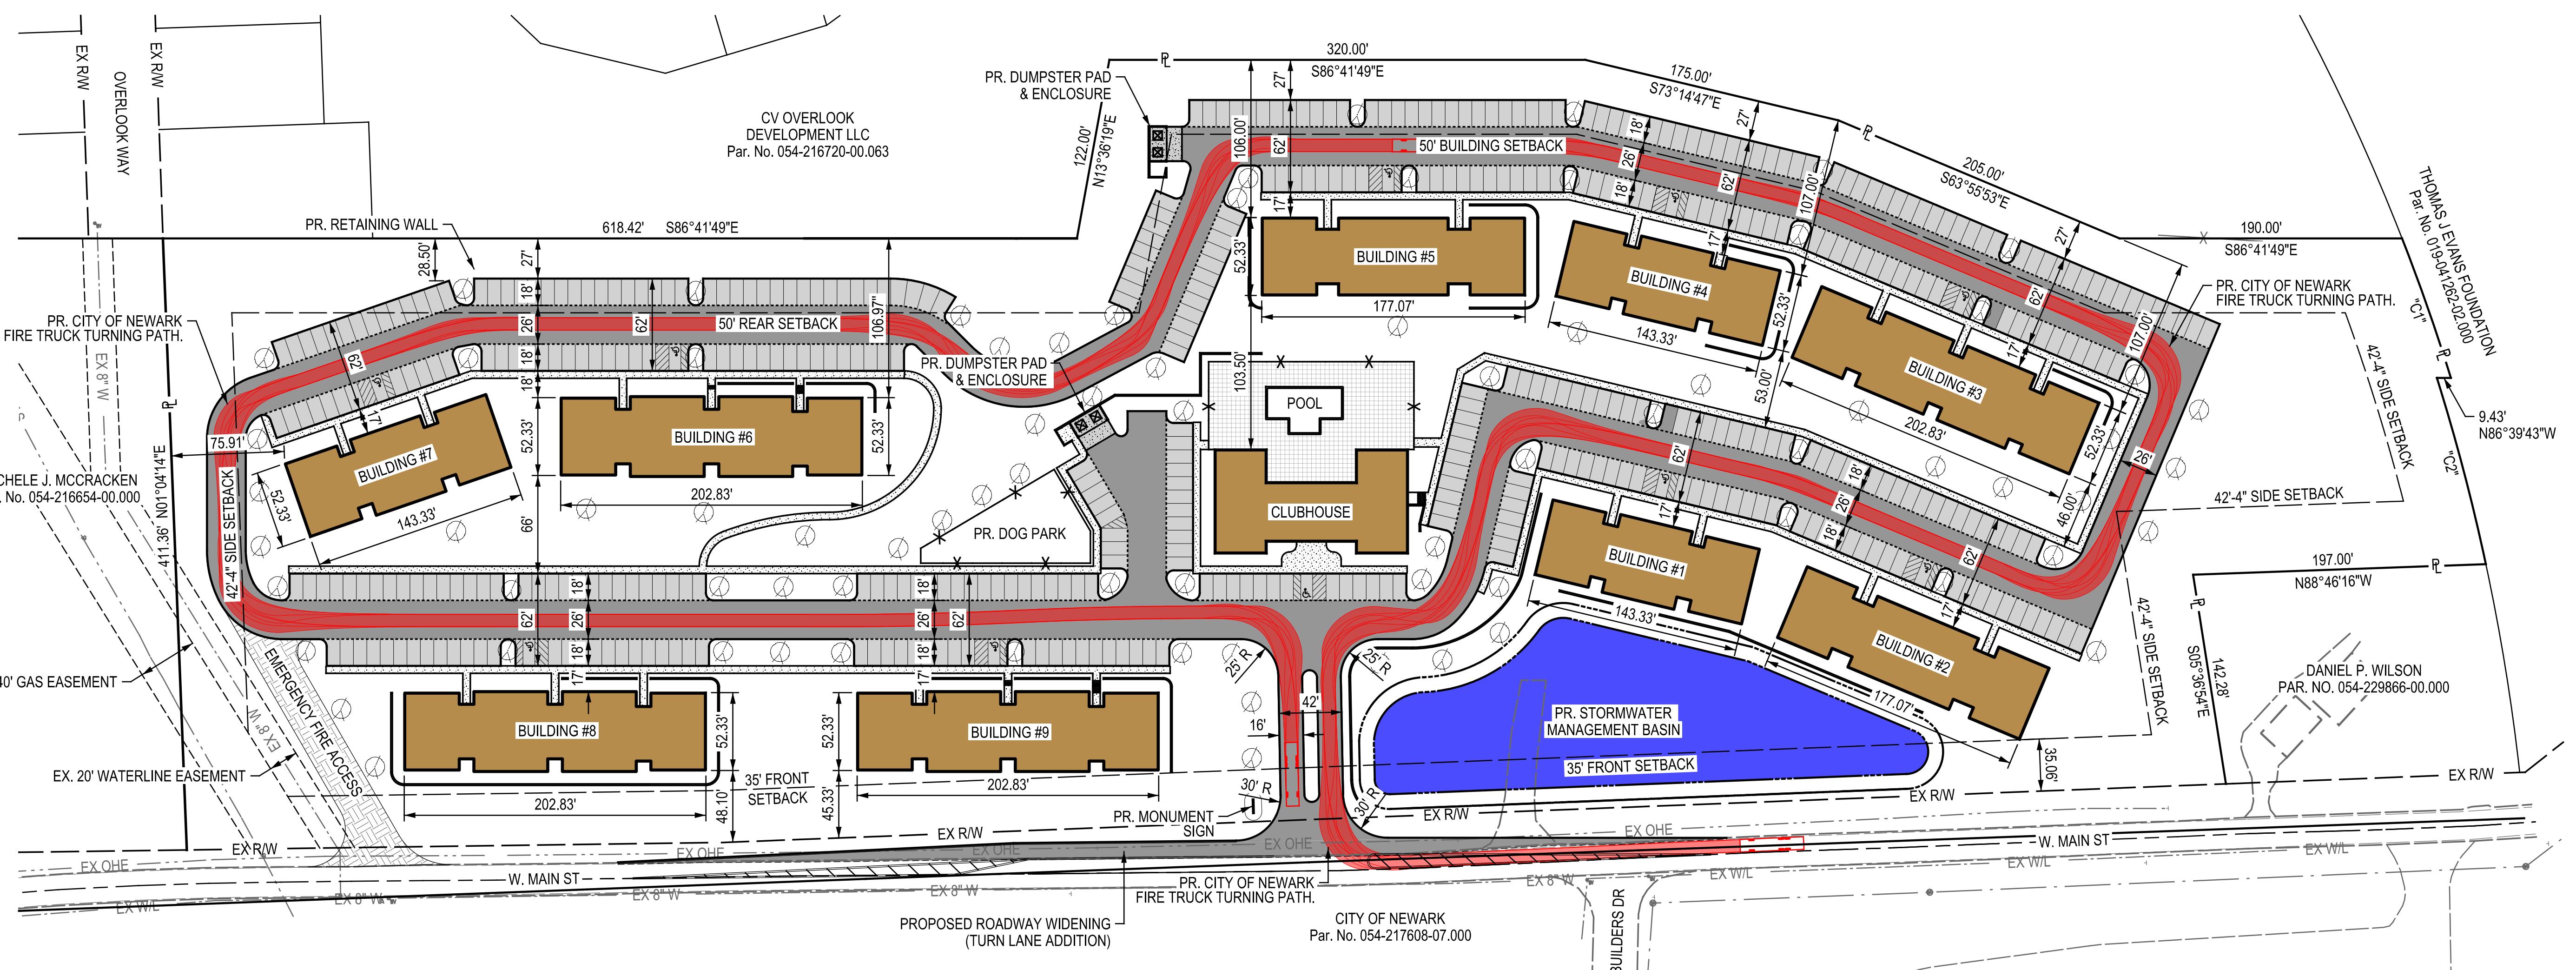


NOTE: MINIMUM DISTANCE BETWEEN BUILDINGS SHALL BE 18'

BOUNDARY CURVE TABLE					
No.	DELTA	RADIUS	LENGTH	Ch. BEARING	Ch. DISTANCE
"C1"	04°01'55"	1411.39'	99.32'	S15°59'43"E	99.30'
"C2"	04°44'50"	1402.39'	116.20'	S11°43'13"E	116.16'


LIGHT DUTY ASPHALT  
PAVEMENT AREA

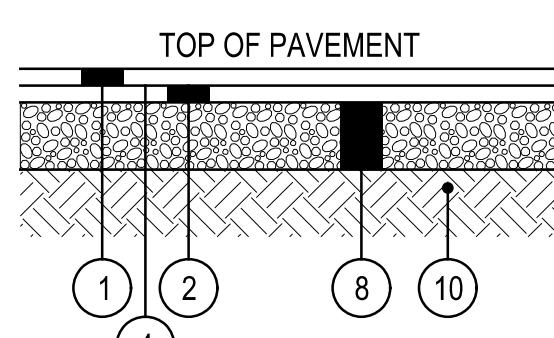


HEAVY DUTY ASPHALT  
PAVEMENT AREA

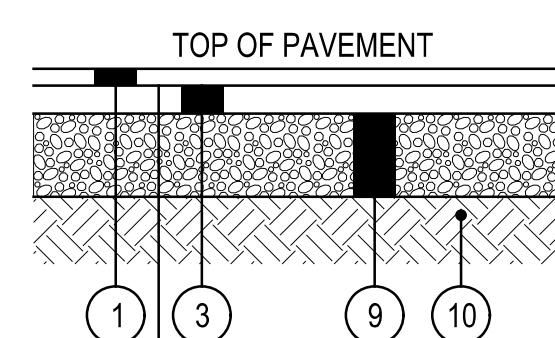

P.C. CONCRETE  
PAVEMENT AREA

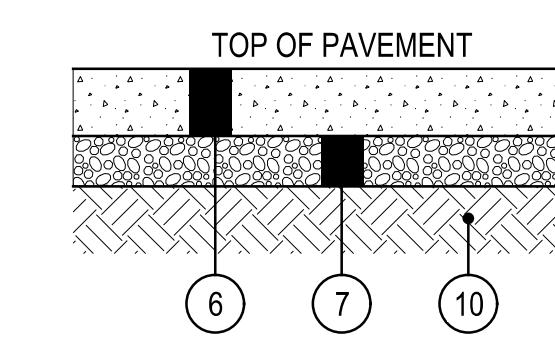

STANDARD COMBINED CURB  
AND WALK DETAIL

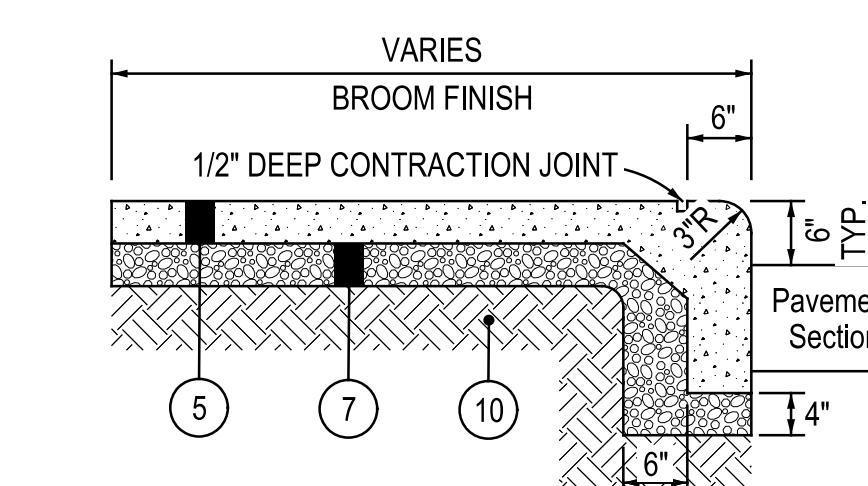


STANDARD CONCRETE WALK WHERE CURB IS NOT PRESENT SHALL MATCH THE BUILD-UP OF THIS DETAIL.  
PAYMENT FOR THE SIDEWALK PORTION OF THIS DETAIL SHALL BE INCLUDED WITH ITEM 608 - 4" CONCRETE WALK.  
PAYMENT FOR THE CURB PORTION OF THIS DETAIL SHALL BE INCLUDED WITH ITEM 609 - CURB, STRAIGHT 18".

PAVEMENT DETAIL LEGEND

- (1) ITEM 441 1 1/2" ASPHALT CONCRETE, SURFACE COURSE, TYPE 1 (448), PG64-22
- (2) ITEM 441 1 1/2" ASPHALT CONCRETE, INTERMEDIATE COURSE, TYPE 2 (448)
- (3) ITEM 441 2 1/2" ASPHALT CONCRETE, INTERMEDIATE COURSE, TYPE 2 (448)
- (4) ITEM 407 NON-TRACKING TACK COAT
- (5) ITEM 608 4" CONCRETE WALK
- (6) ITEM 452 8" NON-REINFORCED P.C. CONCRETE PAVEMENT, CLASS C
- (7) ITEM 304 4" AGGREGATE BASE
- (8) ITEM 304 8" AGGREGATE BASE
- (9) ITEM 304 10" AGGREGATE BASE
- (10) ITEM 204 SUBGRADE COMPACTION
- (11) ITEM 659 3" TOPSOIL

DUMPSTER PAD &  
ENCLOSURE DETAIL



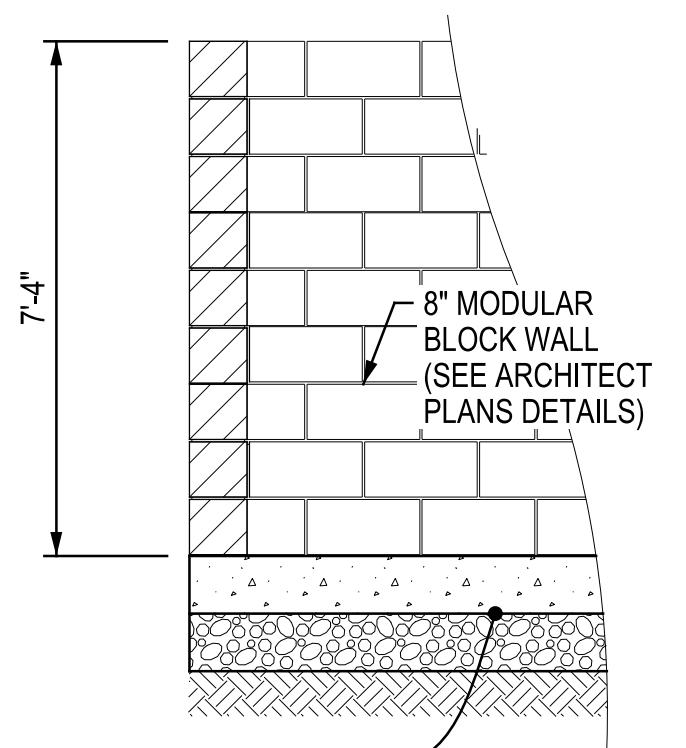


**ADR**  
ARCHITECTURAL DESIGN  
REVIEW

83 West Church Street • Newark, OH 43055 • (740) 245-1921



# SIGHT DISTANCE EXHIBIT (PREFERRED LOCATION)

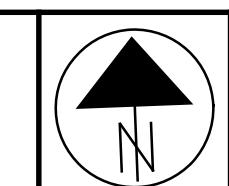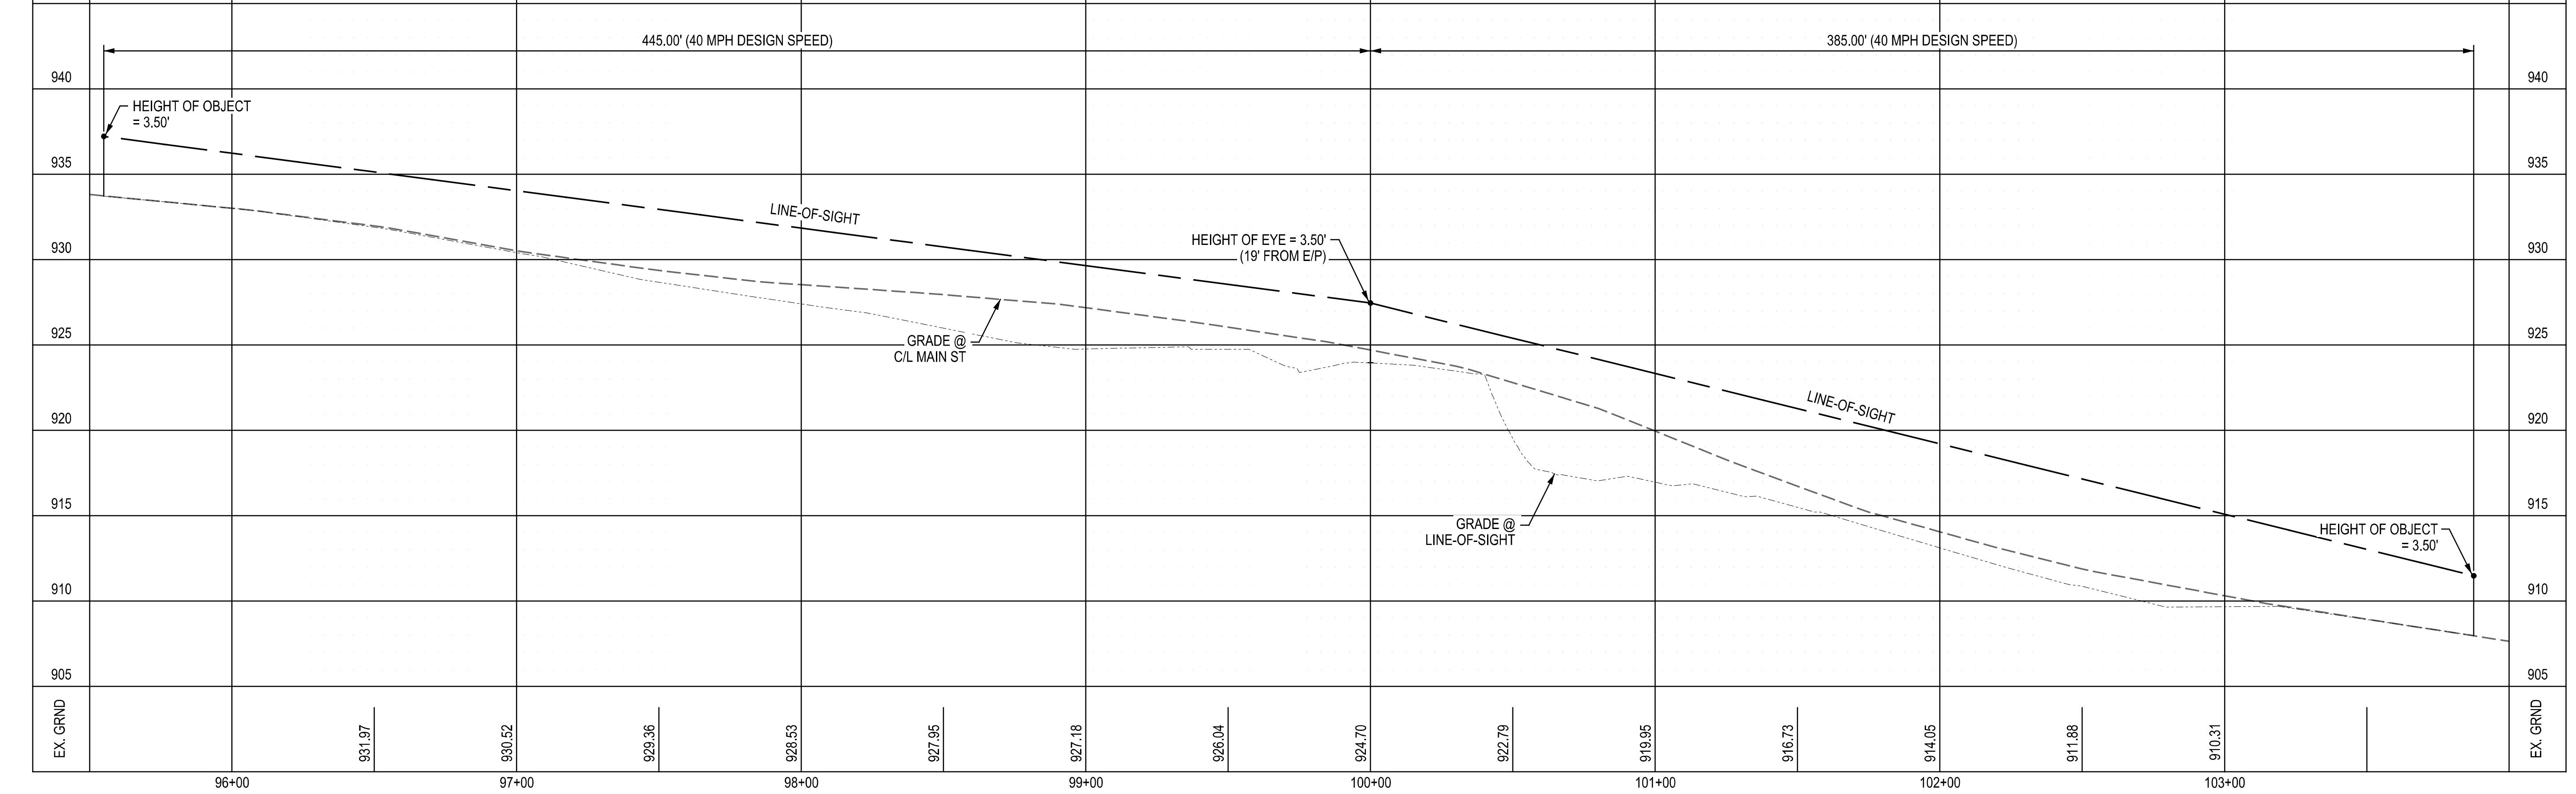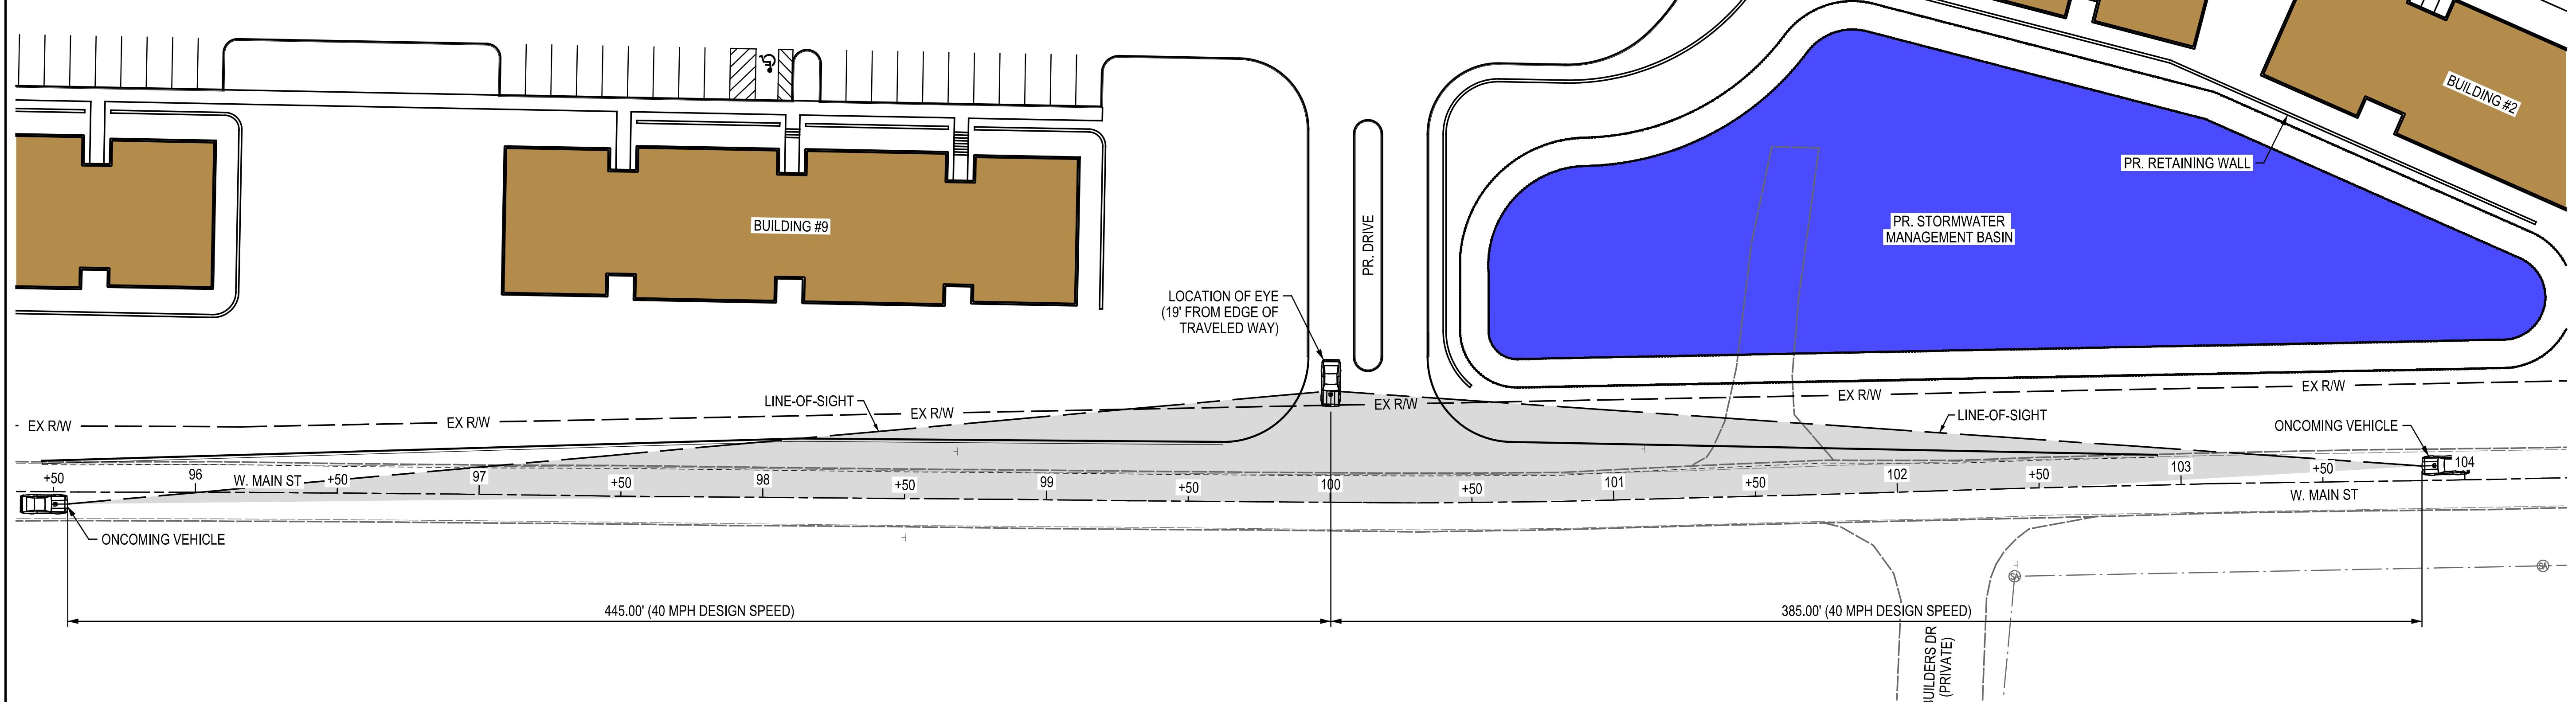

60  
30  
0  
60  
30  
0  
10  
5  
0  
10  
5  
0

HORIZONTAL SCALE IN FEET  
VERTICAL SCALE IN FEET




**ADR**  
A Division of AECOM  
88 West Church Street • Newark, OH 44662 • (740) 345-1921

REVISIONS  
DRAWN BY: JAM  
AJM  
CHECKED BY: BWW  
BWW  
REVIEWED BY: JWD  
JWD  
APPROVED BY: JWD  
JWD  
REVISED BY: JWD  
JWD  
DATE: 12/8/2023  
TIME: 10:07:30 AM

**TRAILHEAD VISTA  
CITY OF NEWARK**  
**SIGHT DISTANCE EXHIBIT  
(PREFERRED LOCATION)**

DEC. 8, 2023  
JOB #23-062  
3  
4

# SIGHT DISTANCE EXHIBIT (ALTERNATIVE LOCATION)

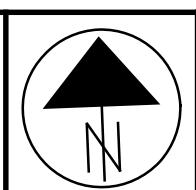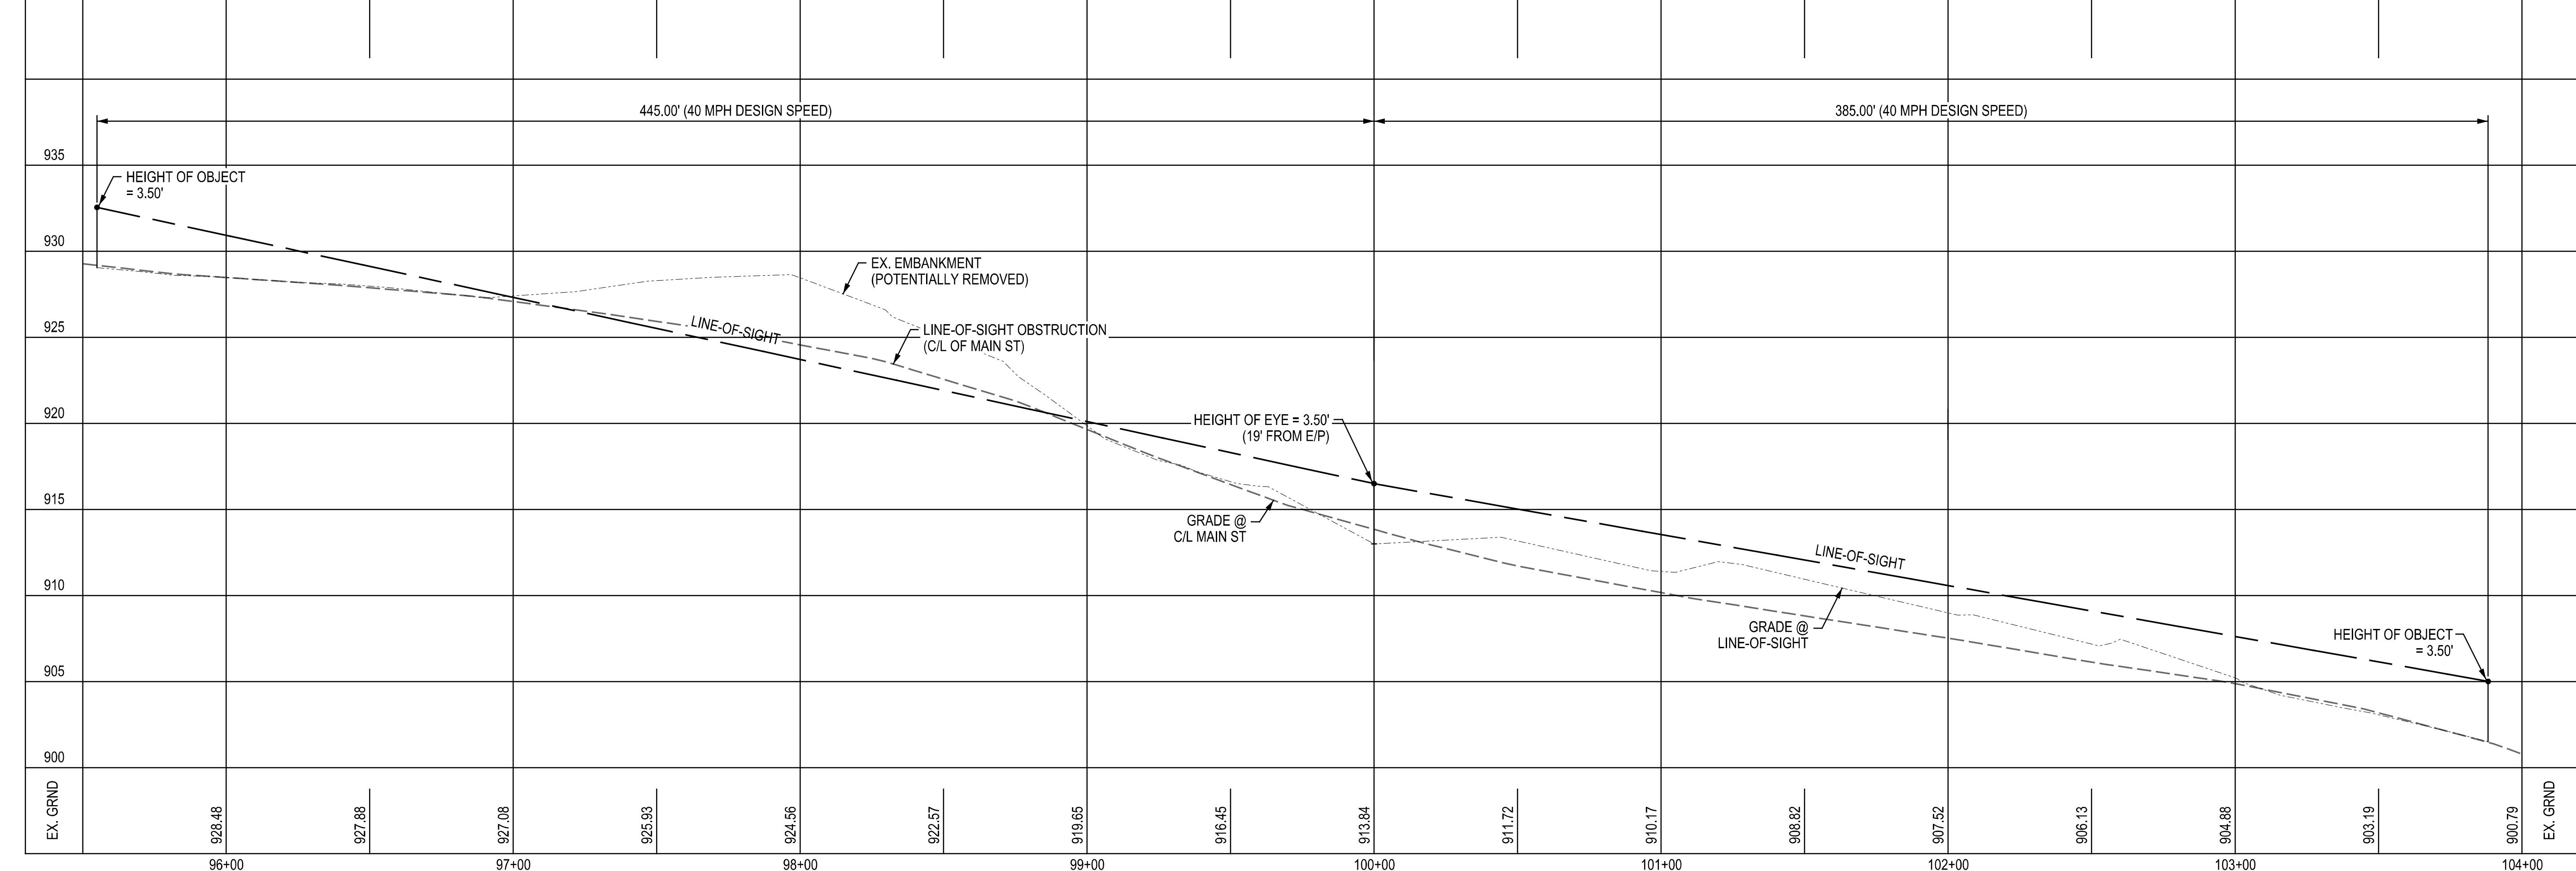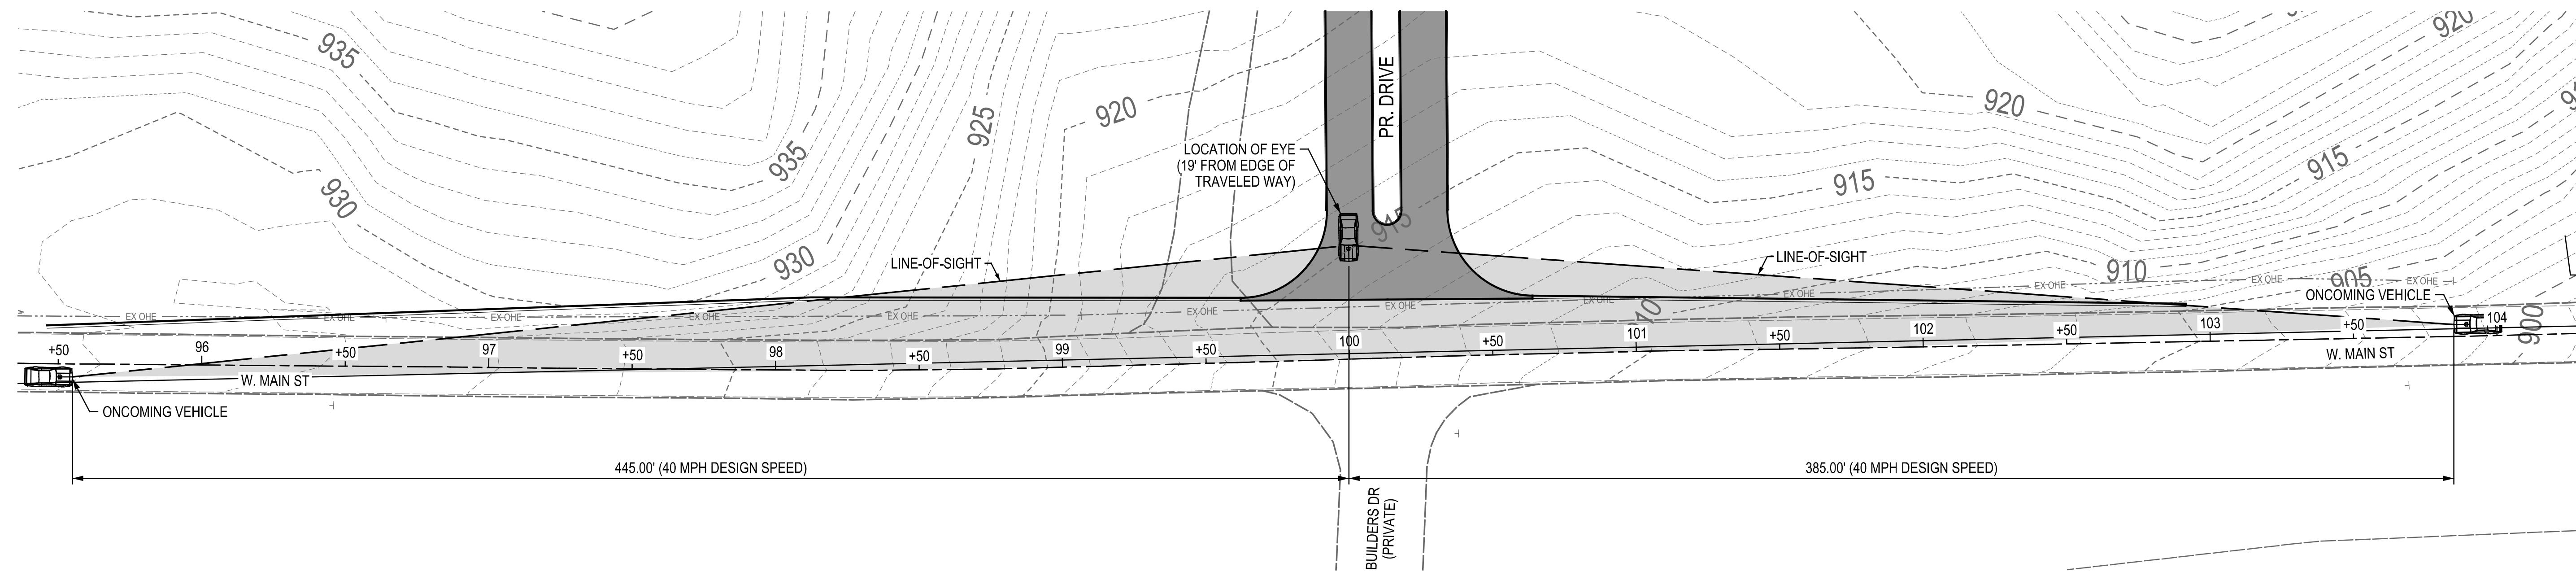

0 30 60  
0 5 10  
HORIZONTAL SCALE IN FEET  
VERTICAL SCALE IN FEET

**ADR**  
AEC Associates, Inc.  
81 West Church Street • Newark, OH 44662 • (740) 245-1921

REVISIONS	
△ -	△ -

1 -

SIGHT DISTANCE EXHIBIT  
(ALTERNATIVE LOCATION)

TRAILHEAD VISTA  
CITY OF NEWARK

DEC. 8, 2023  
JOB #23-062

4  
4

CONSULTANTS

## TRAILHEAD VISTA

NEWARK, OH

Vista Residential Partners

2964 Peachtree Road  
Atlanta, GA 30305

CLIENT

PROJECT NO.

Date: 12/05/23

Issued for: City Review

REVISIONS

LANDSCAPE  
PLAN

PRELIMINARY  
NOT FOR CONSTRUCTION

L1.01  
Sheet Number

Sheet Title

SEAL

### GENERAL LANDSCAPE NOTES:


1. EACH CONTRACTOR IS TO VERIFY WITH OWNER AND UTILITY COMPANIES THE LOCATIONS OF ALL UTILITIES PRIOR TO CONSTRUCTION, TO DETERMINE IN THE FIELD THE ACTUAL LOCATIONS AND ELEVATIONS OF ALL EXISTING UTILITIES, WHETHER SHOWN ON THE PLANS OR NOT. THE CONTRACTOR SHALL CALL UTILITY PROTECTION SERVICE 72 HOURS PRIOR TO CONSTRUCTION.
2. EXAMINE FINISH SURFACE, GRADES, TOPSOIL QUALITY AND DEPTH. DO NOT START ANY WORK UNTIL UNSATISFACTORY CONDITIONS HAVE BEEN CORRECTED. VERIFY LIMITS OF WORK BEFORE STARTING.
3. CONTRACTOR RESPONSIBLE FOR COST OF REPAIRS TO EXISTING SITE CONDITIONS WHEN DAMAGED BY CONTRACTOR. REPAIR TO THE SATISFACTION OF THE OWNER.
4. ALL PLANT MASSES TO BE CONTAINED WITHIN 3" DEEP HARDWOOD BARK MULCH BED.
5. CONTRACTOR SHALL MAINTAIN POSITIVE DRAINAGE IN LAWN AREAS.
6. FINE GRADE LAWN AREAS TO PROVIDE A SMOOTH AND CONTINUAL GRADE FREE OF IRRREGULARITIES OR DEPRESSIONS.
7. CONTRACTOR SHALL SEED OR SOD ALL AREAS DISTURBED DURING CONSTRUCTION, SEE PLAN.
8. ALL PLANTS SHALL MEET OR EXCEED STANDARDS SET IN THE U.S.A. STANDARD FOR NURSERY STOCK.
9. ALL PLANTING OPERATIONS SHALL ADHERE TO THE AMERICAN ASSOCIATION OF NURSERYMEN STANDARDS.
10. ABOVE GROUND UTILITIES SHALL BE SCREENED WITH EVERGREEN PLANTING AND BE PROVIDED UPON FINAL ENGINEERING.

### LANDSCAPE CODE SUMMARY

CODE SECTION	REQUIRED	PROVIDED
125.3 - Development and Maintenance of Parking Areas 1. Screening and Landscaping	...screening shall be between 4 and 6 feet in height and shall be maintained in good condition. Landscaping provided in lieu of such screening shall consist of a strip of land not less than 15 feet in width planted with an evergreen hedge, or planting of evergreen shrubs not less than 4 feet in height, providing a continuous 75% opaque buffer.	4' hgt. evergreen hedge provided along north facing parking as indicated on plan
130.6.6 - Multi-Family and Green Space Requirements	Square Foot of Green Space Unit numbers SF of Green Space 3 4,500 4 add 500 per unit beyond 4 add 500 per (4) units or fraction thereof Count - based on 308 units 4,500 152,500 38,000 195,000 sf required 320,334 sf of green space provided	
130.6.6 - Multi-Family and Green Space Requirements	Number of Trees Unit numbers Number of Trees 3 5 4 add 1 per unit beyond 4 add 1 per (4) units or fraction thereof Count - based on 308 units 1 1 76 78 trees required 79 trees provided	


### CONSTRUCTION NOTES:

- MONUMENT SIGN - LOCATION SHOWN IS APPROXIMATE. SIGN TO MEET ZONING REQUIREMENTS. DETAILS TBD AND WILL BE PROVIDED UPON FINAL ENGINEERING.

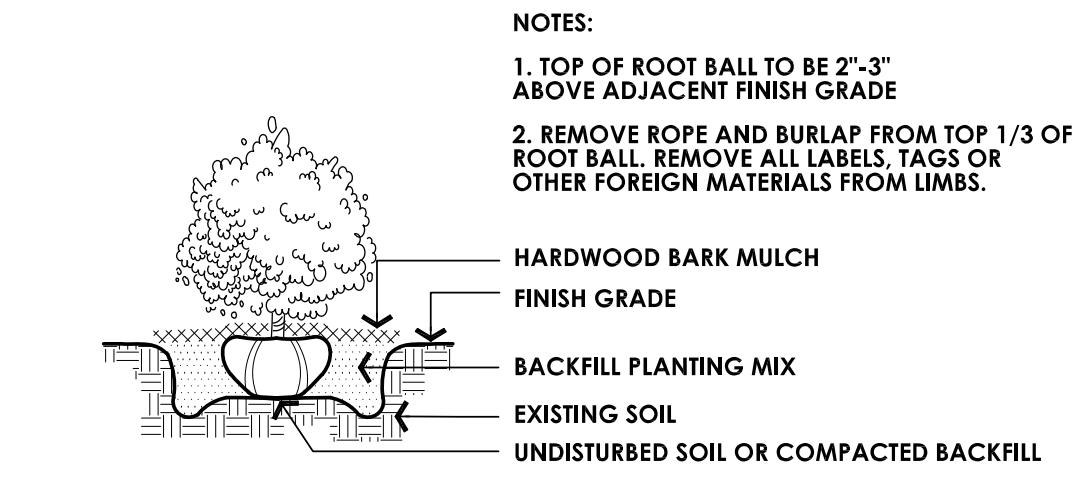

### SHRUB PLANTING DETAIL

NTS

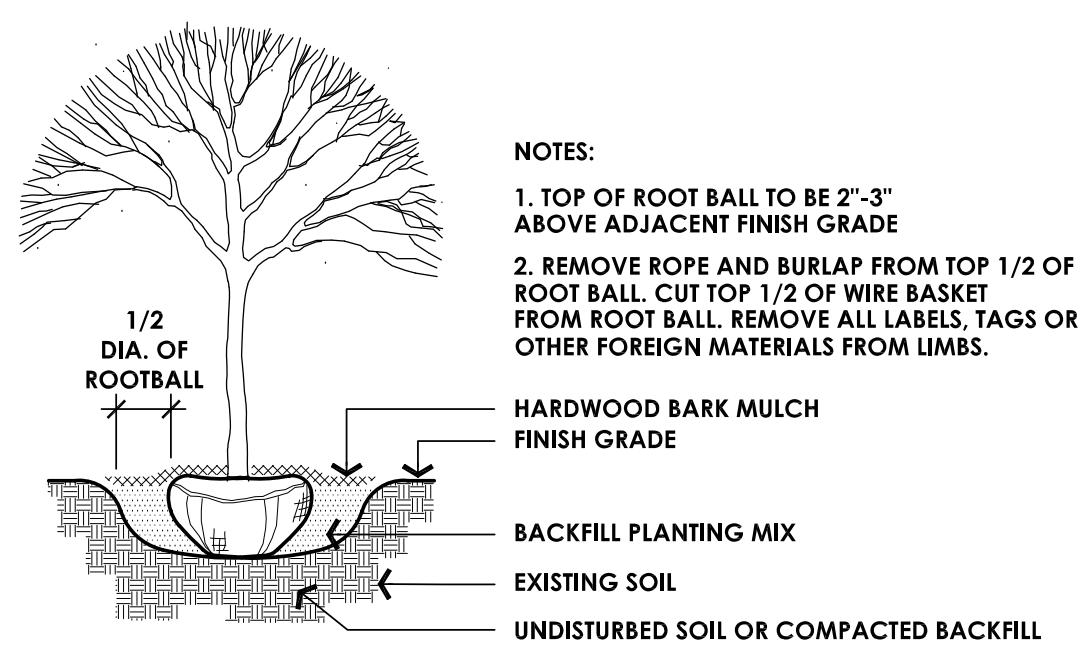



### DECIDUOUS TREE PLANTING DETAIL

NTS


### PLANT MATERIALS LIST

CONTRACTOR RESPONSIBLE FOR ALL PLANT QUANTITIES SHOWN ON PLAN

QTY	ABR	BOTANICAL NAME	COMMON NAME	SIZE	ROOT	REMARKS
<b>SHADE TREES</b>						
18	ARO	Acer Rubrum 'October Glory'	OCTOBER GLORY RED MAPLE	2.5" Cal.	B&B	
5	NS	Nyssa sylvatica	BLACK TUPELO	2.5" Cal.	B&B	
4	TC	Tilia cordata 'Greenspire'	GREENSPIRE LINDEN	2.5" Cal.	B&B	
17	UH	Ulmus 'Homestead'	HOMESTEAD ELM	2.5" Cal.	B&B	
5	QB	Quercus bicolor	SWAMP WHITE OAK	2.5" Cal.	B&B	
26	ZSG	Zelkova Serrata 'Green Vase'	GREEN VASE ZELKOVA	2.5" Cal.	B&B	
<b>SHRUBS</b>						
6	IHG	Itea virginica 'Henry's Garnet'	HENRY'S GARNET SWEETSPIRE	18" Hgt.	Cont.	
298	JCS	Juniperus chinensis 'Sea Green'	SEA GREEN JUNIPER	24" Hgt.	B&B	MAINT. @ 4' MIN HGT. SPACED @ 4' O.C.
<b>PERENNIALS/ GRASSES/ GROUNDCOVER</b>						
12	HHR	Hemerocallis 'Happy Returns'	HAPPY RETURNS DAYLILY	1 Gal.	Cont.	

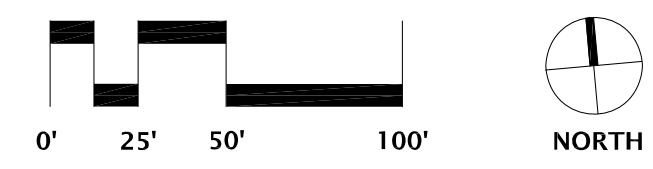
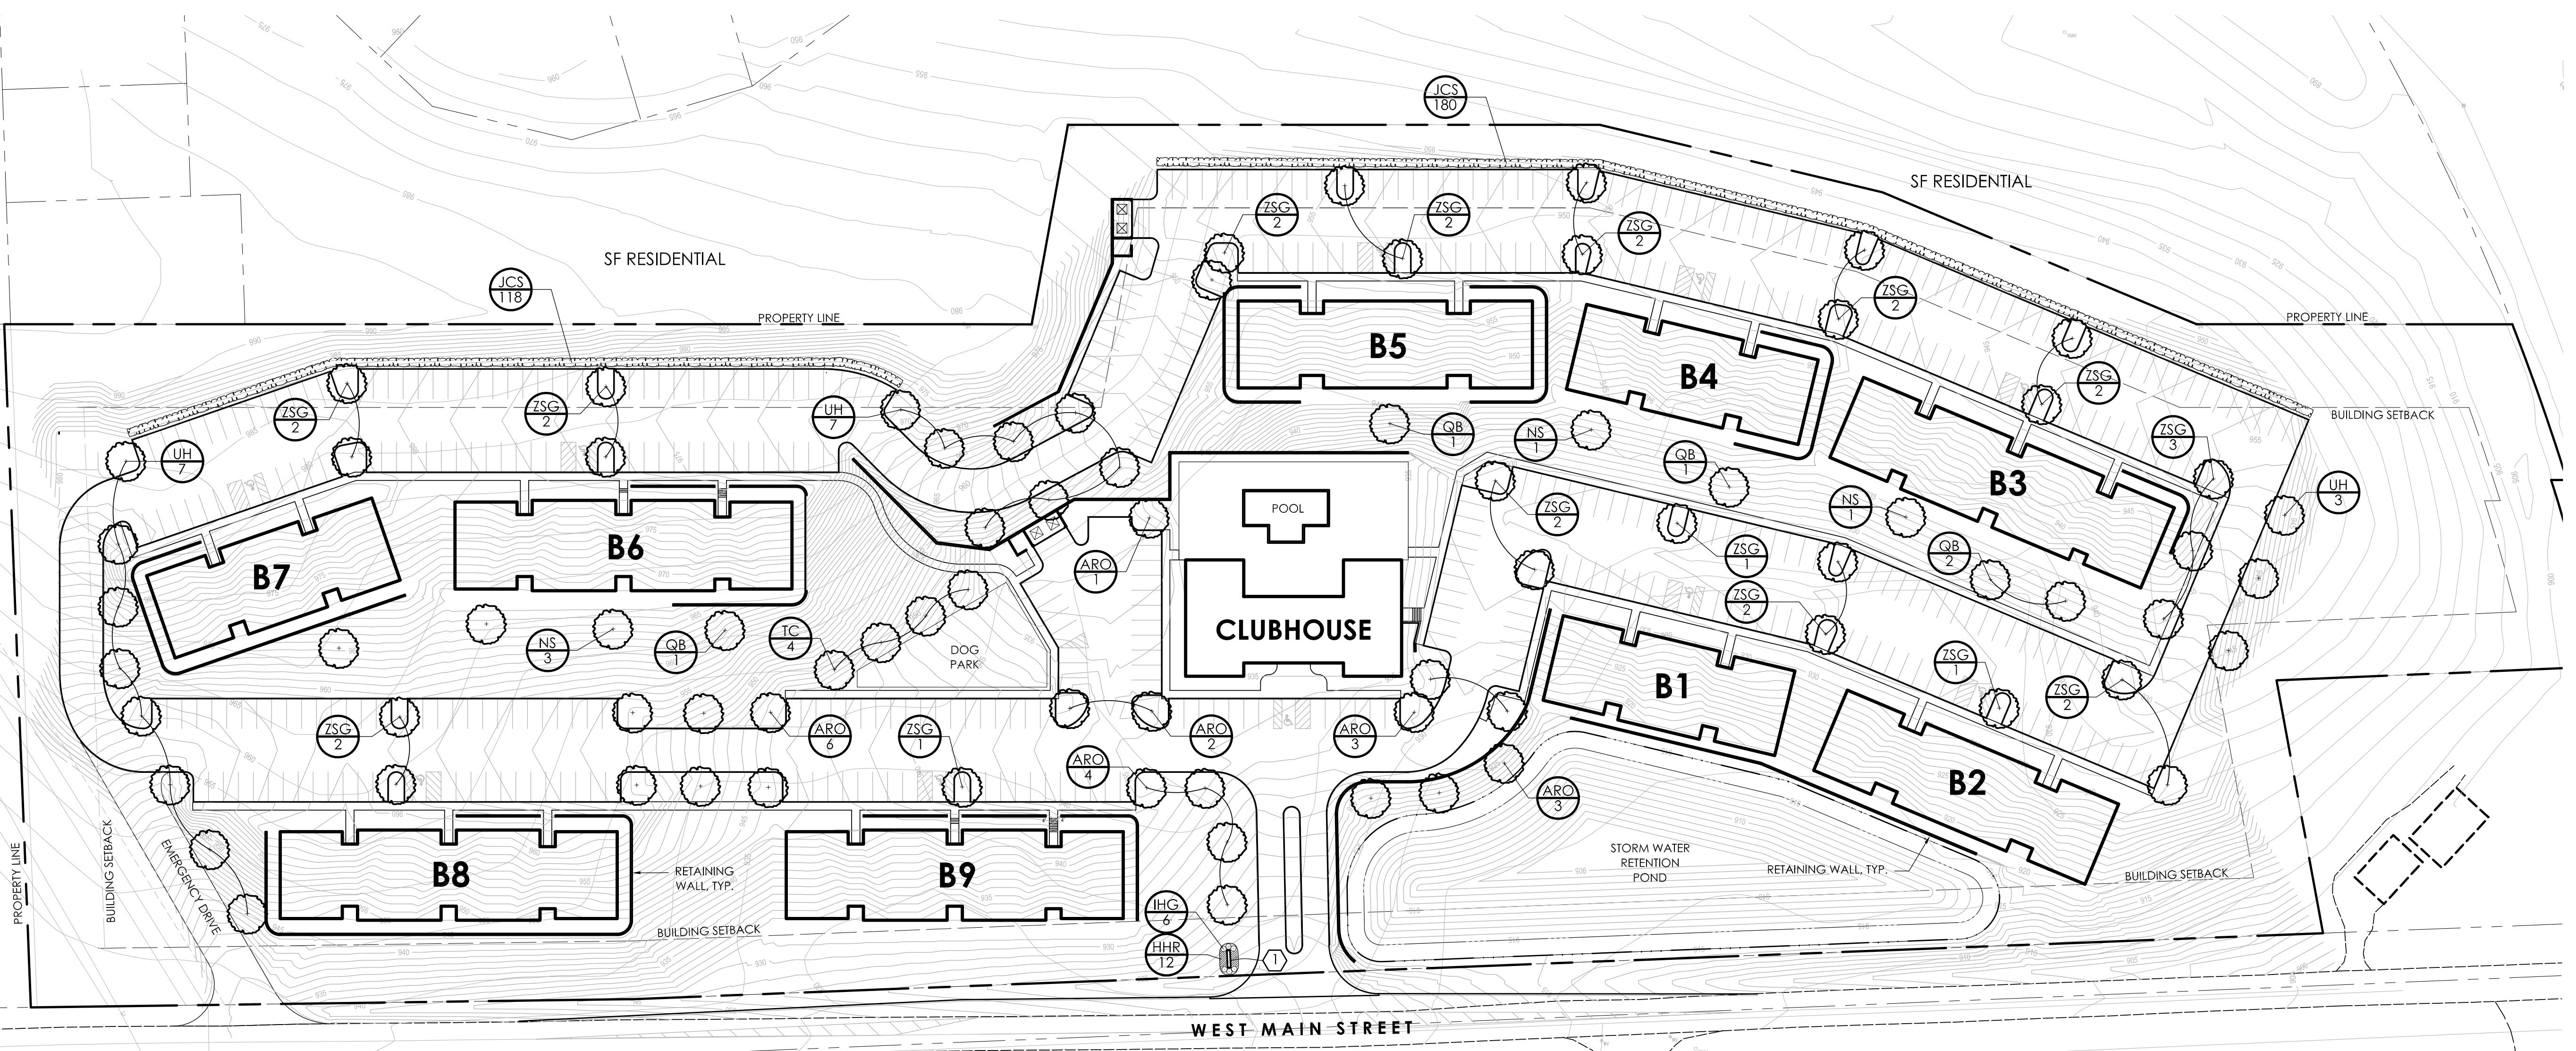


Building Type A // 7,300 SF  
 # Buildings // 03  
 # Levels // 03 / 04 Split  
 Units / BLDG // 28

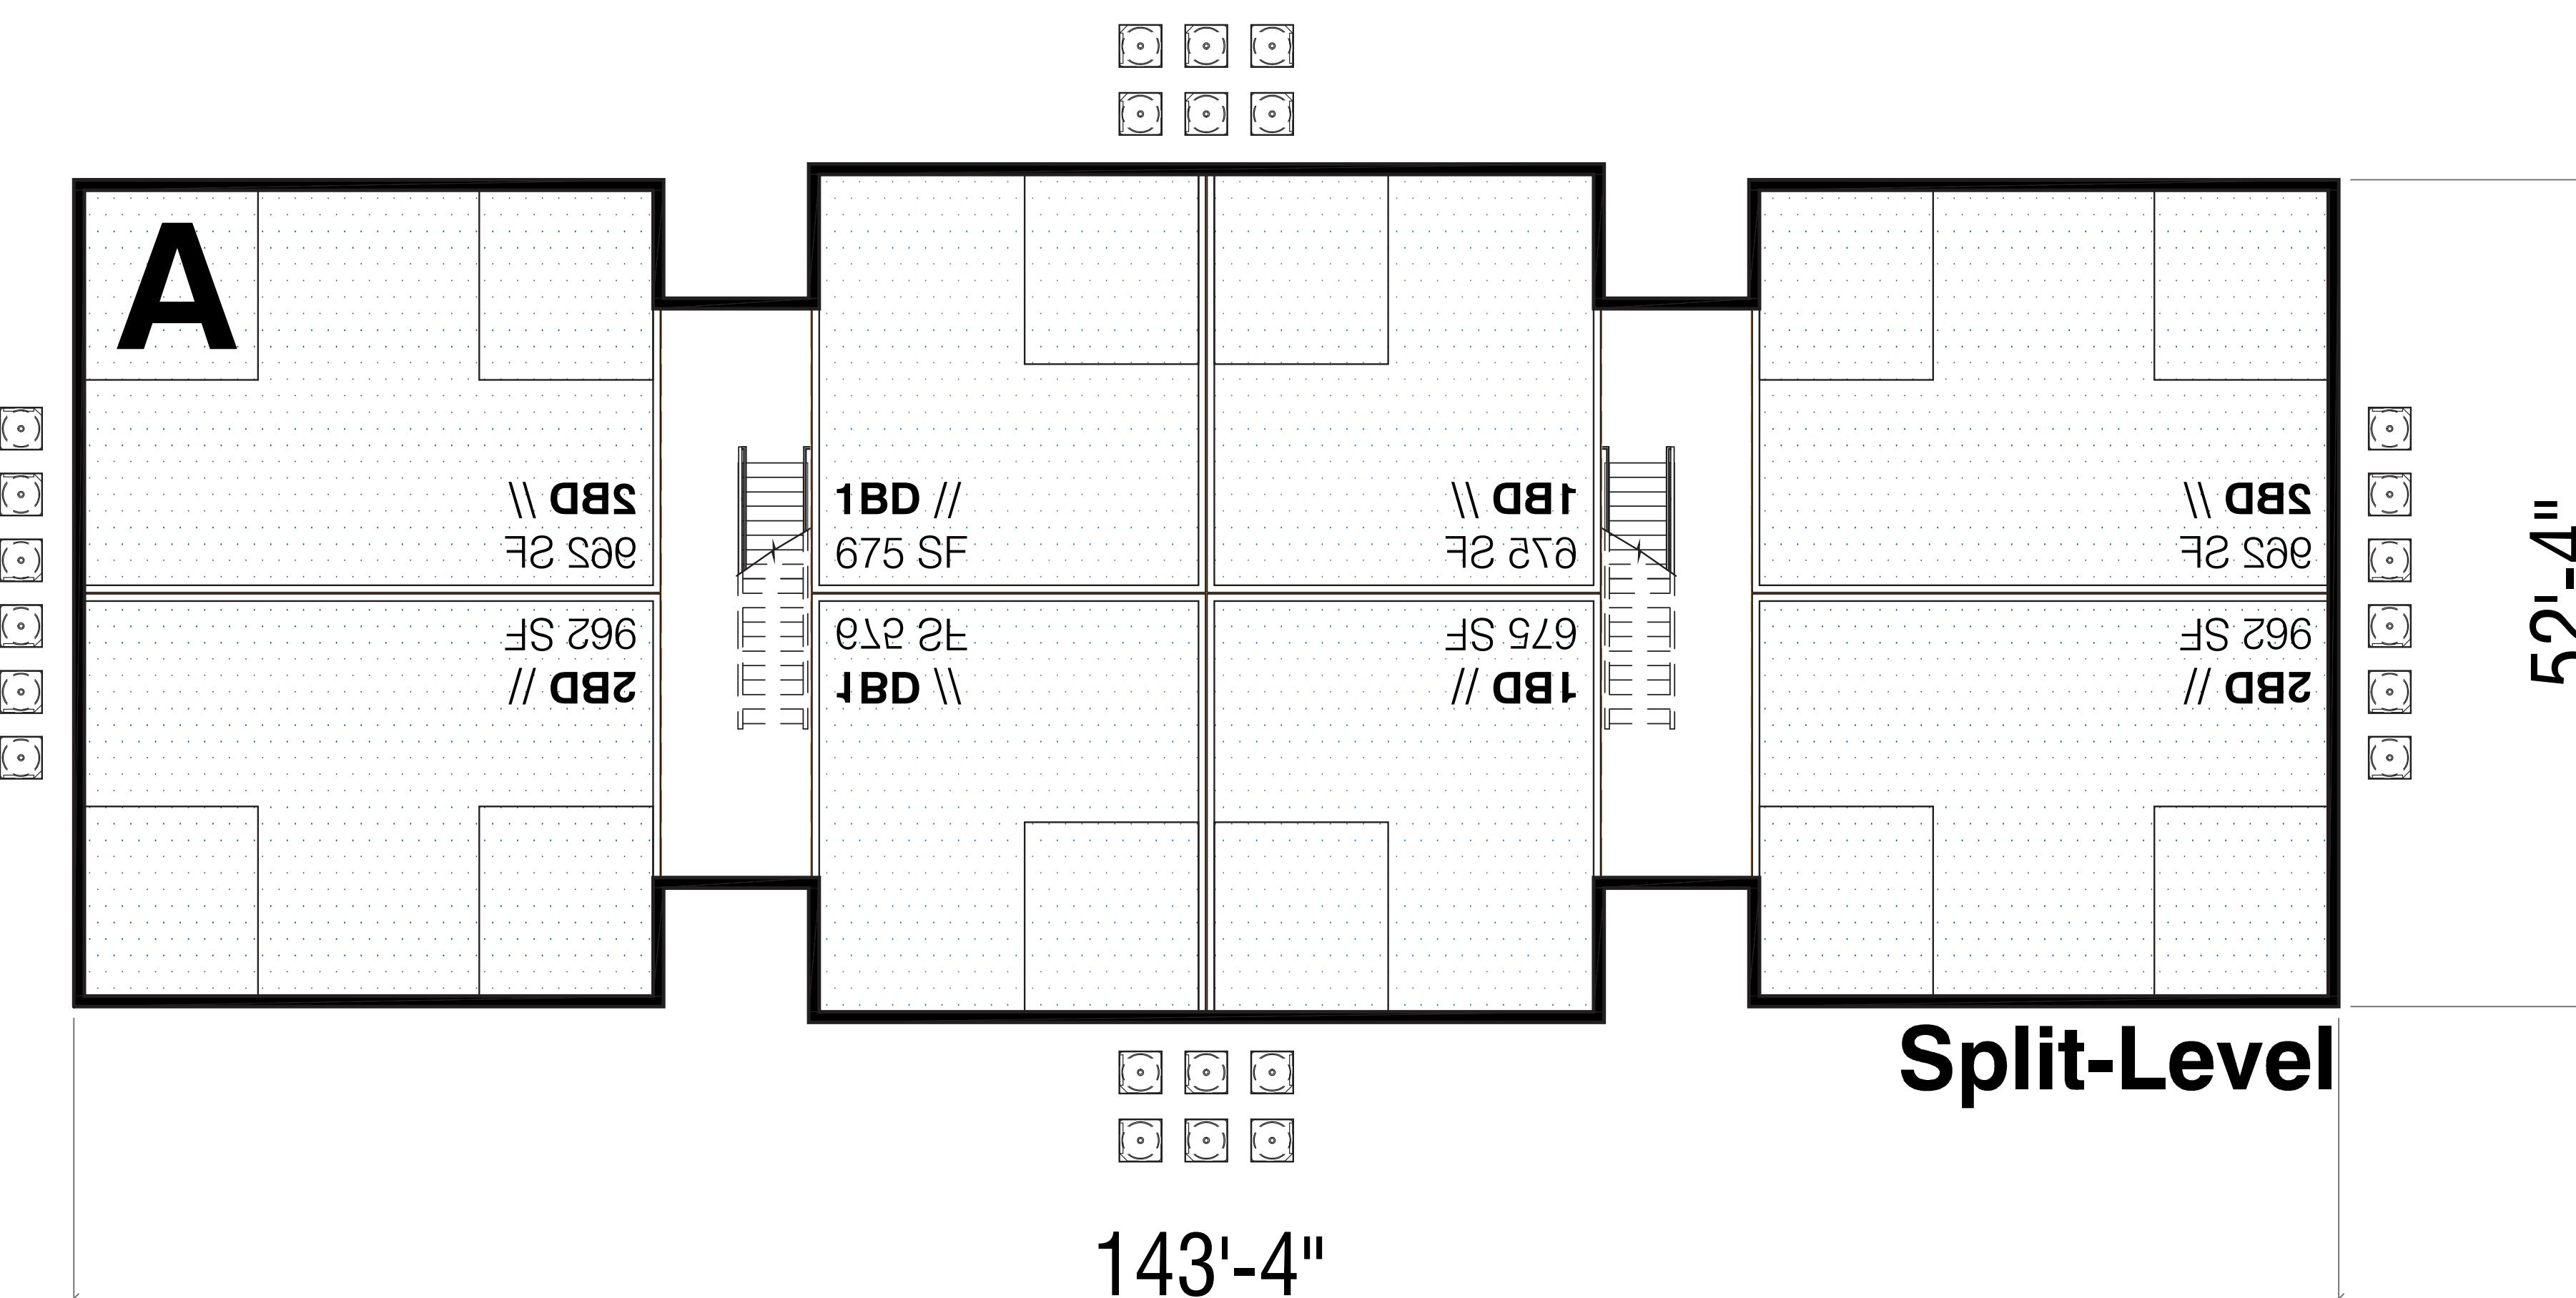





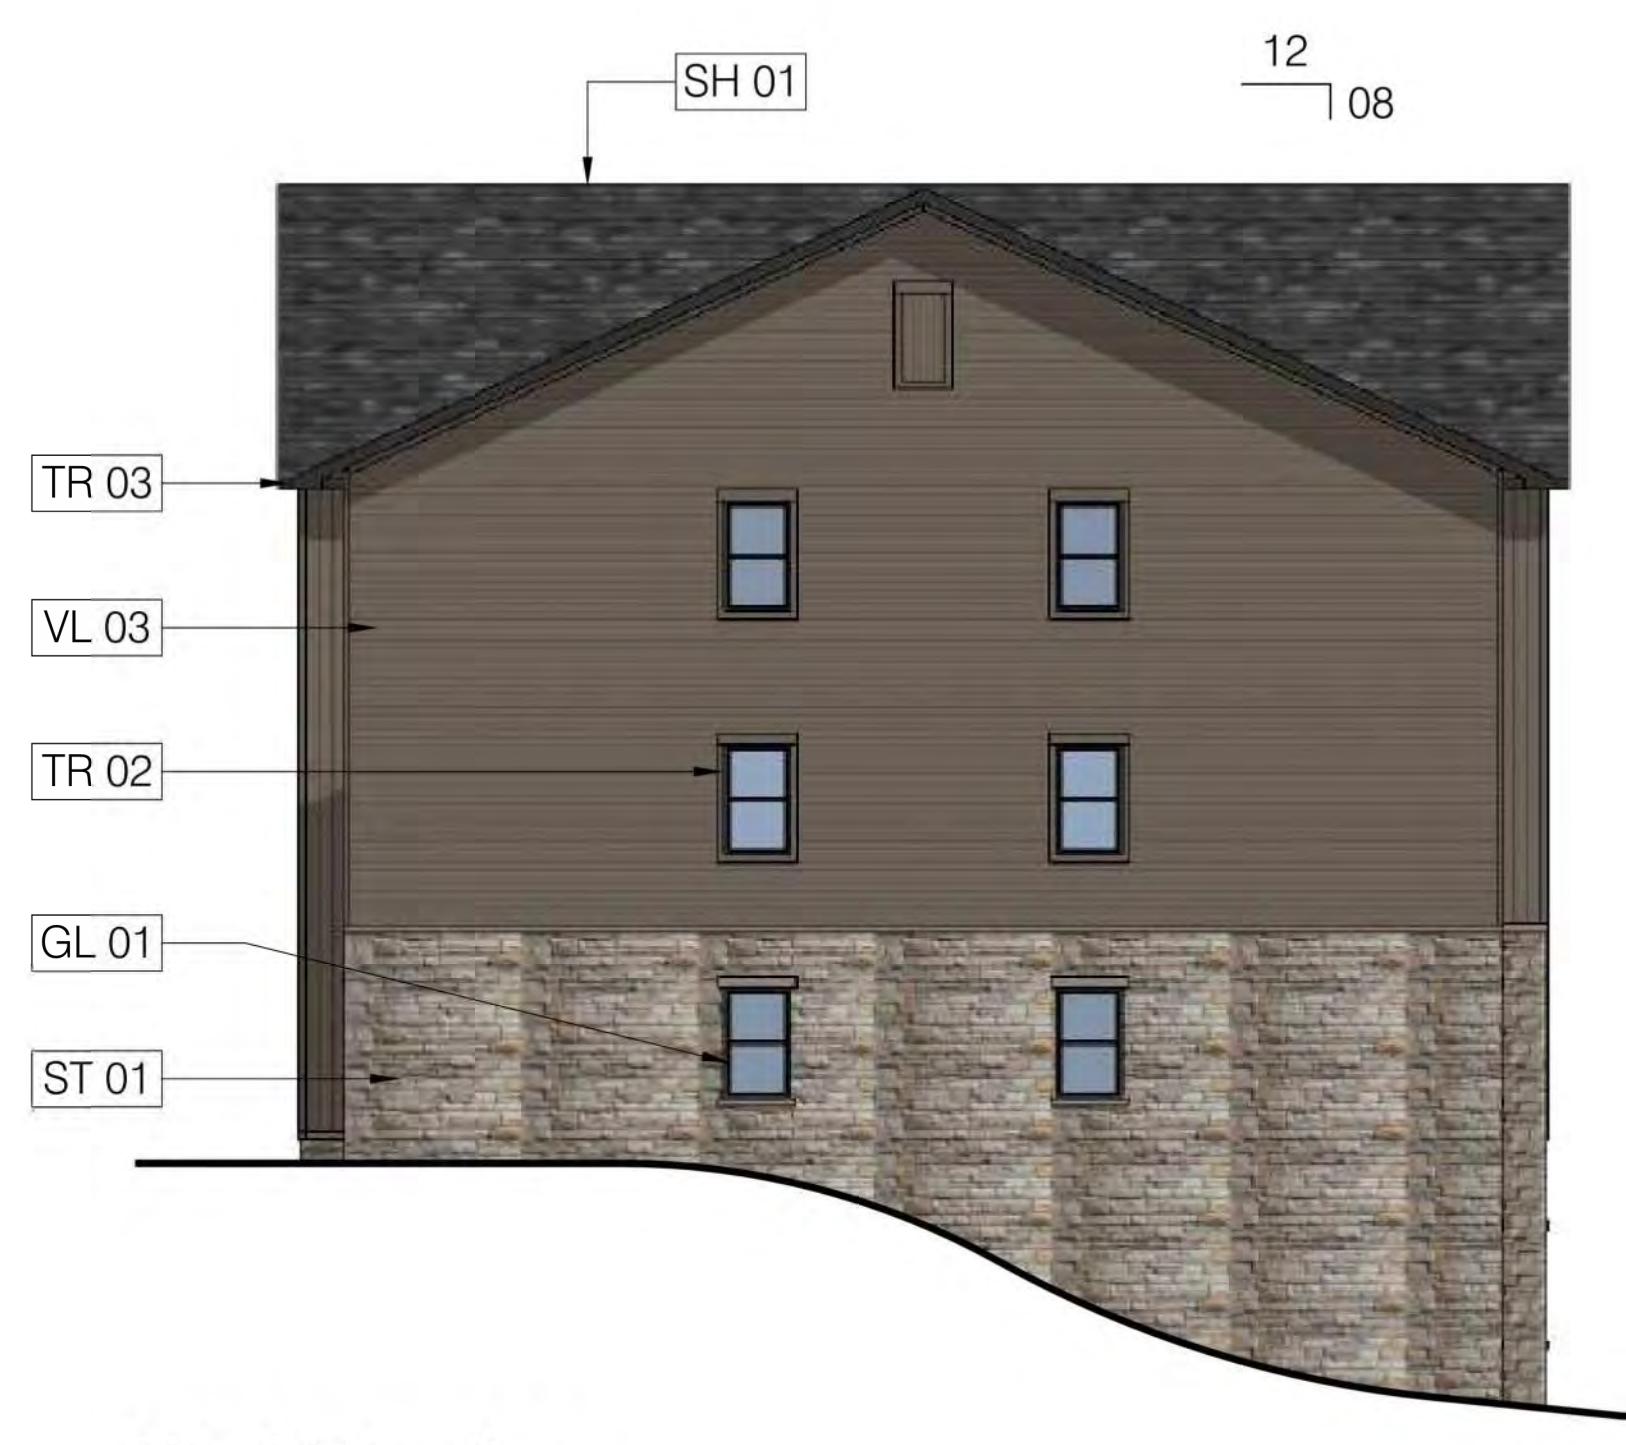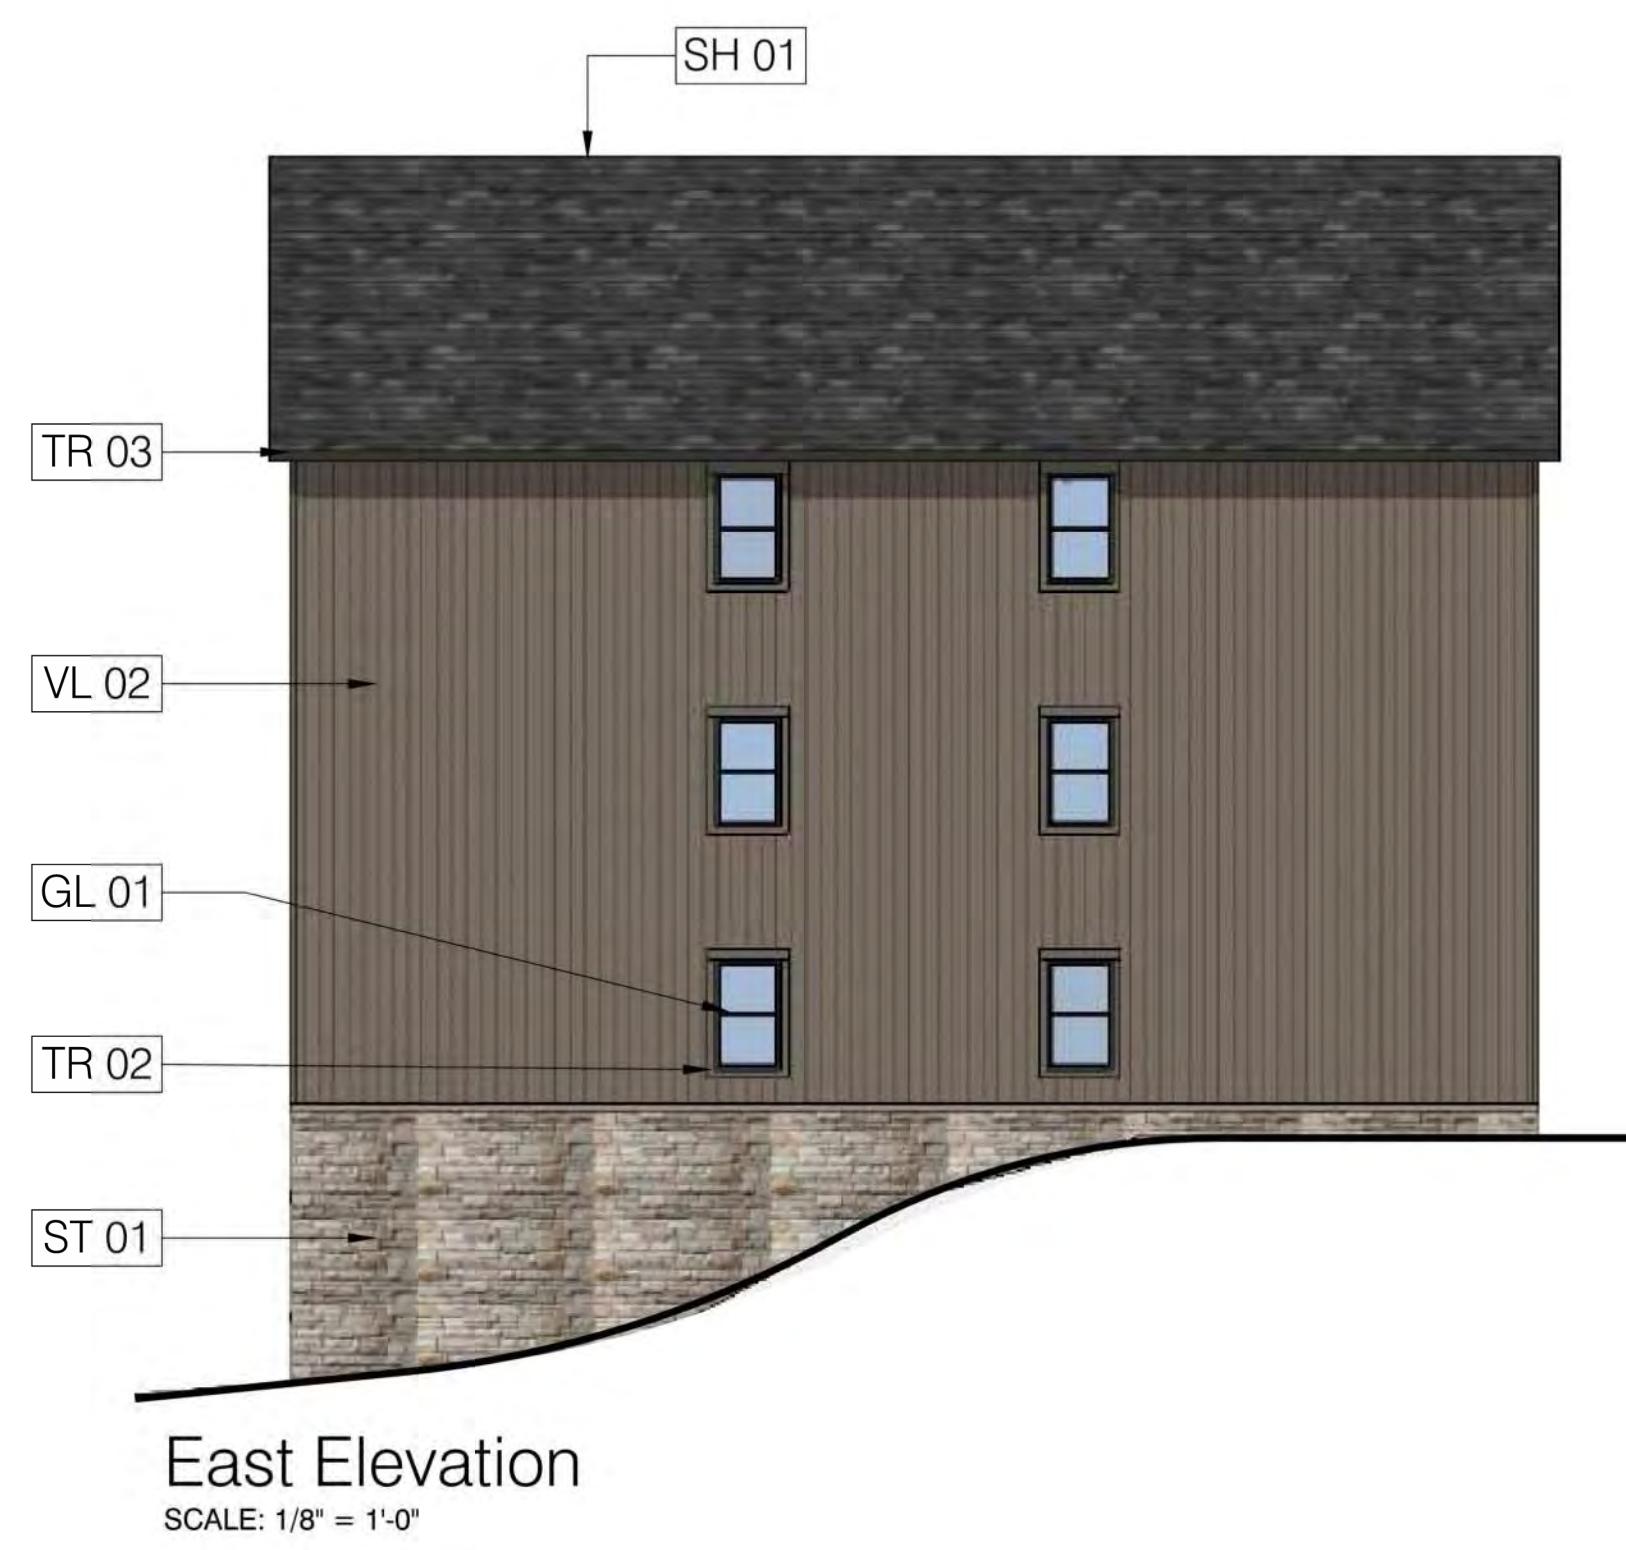

T.O. ROOF  
144'-4"

EAVE  
130'-6"

LEVEL 03  
122'-0"

LEVEL 02  
111'-0"

LEVEL 01  
100'-0"

LEVEL 00  
87'-0"

T.O. ROOF  
144'-4"

EAVE  
130'-6"


LEVEL 03  
122'-0"

LEVEL 02  
111'-0"

LEVEL 01  
100'-0"

LEVEL 00  
87'-0"


Building Type B // 8,850 SF  
 # Buildings // 02  
 # Levels // 03 / 04 Split  
 Units / BLDG // 28

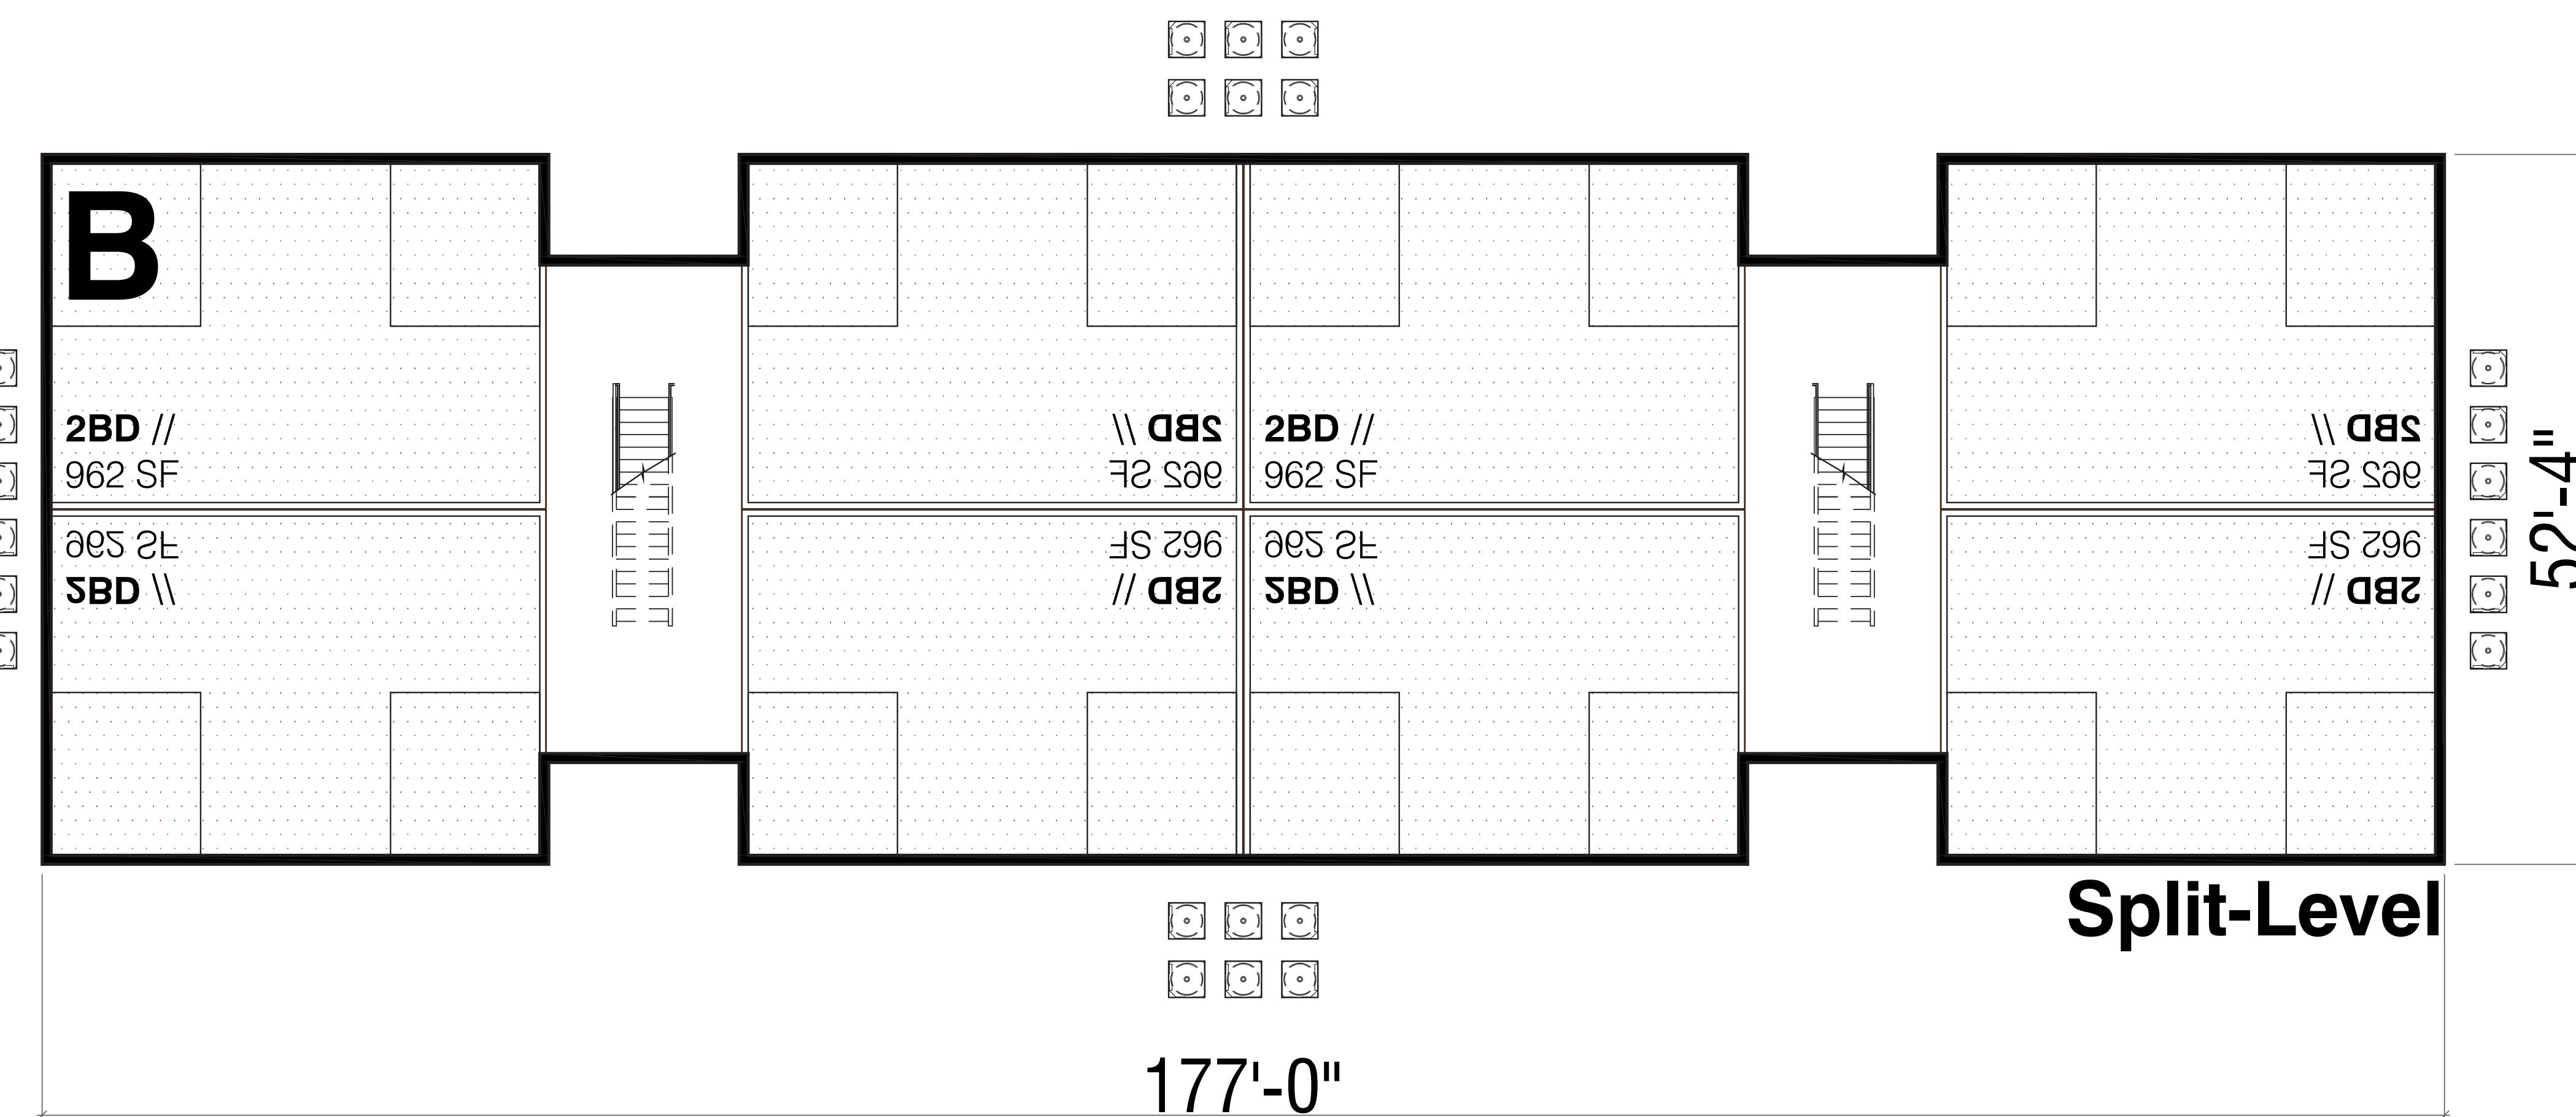








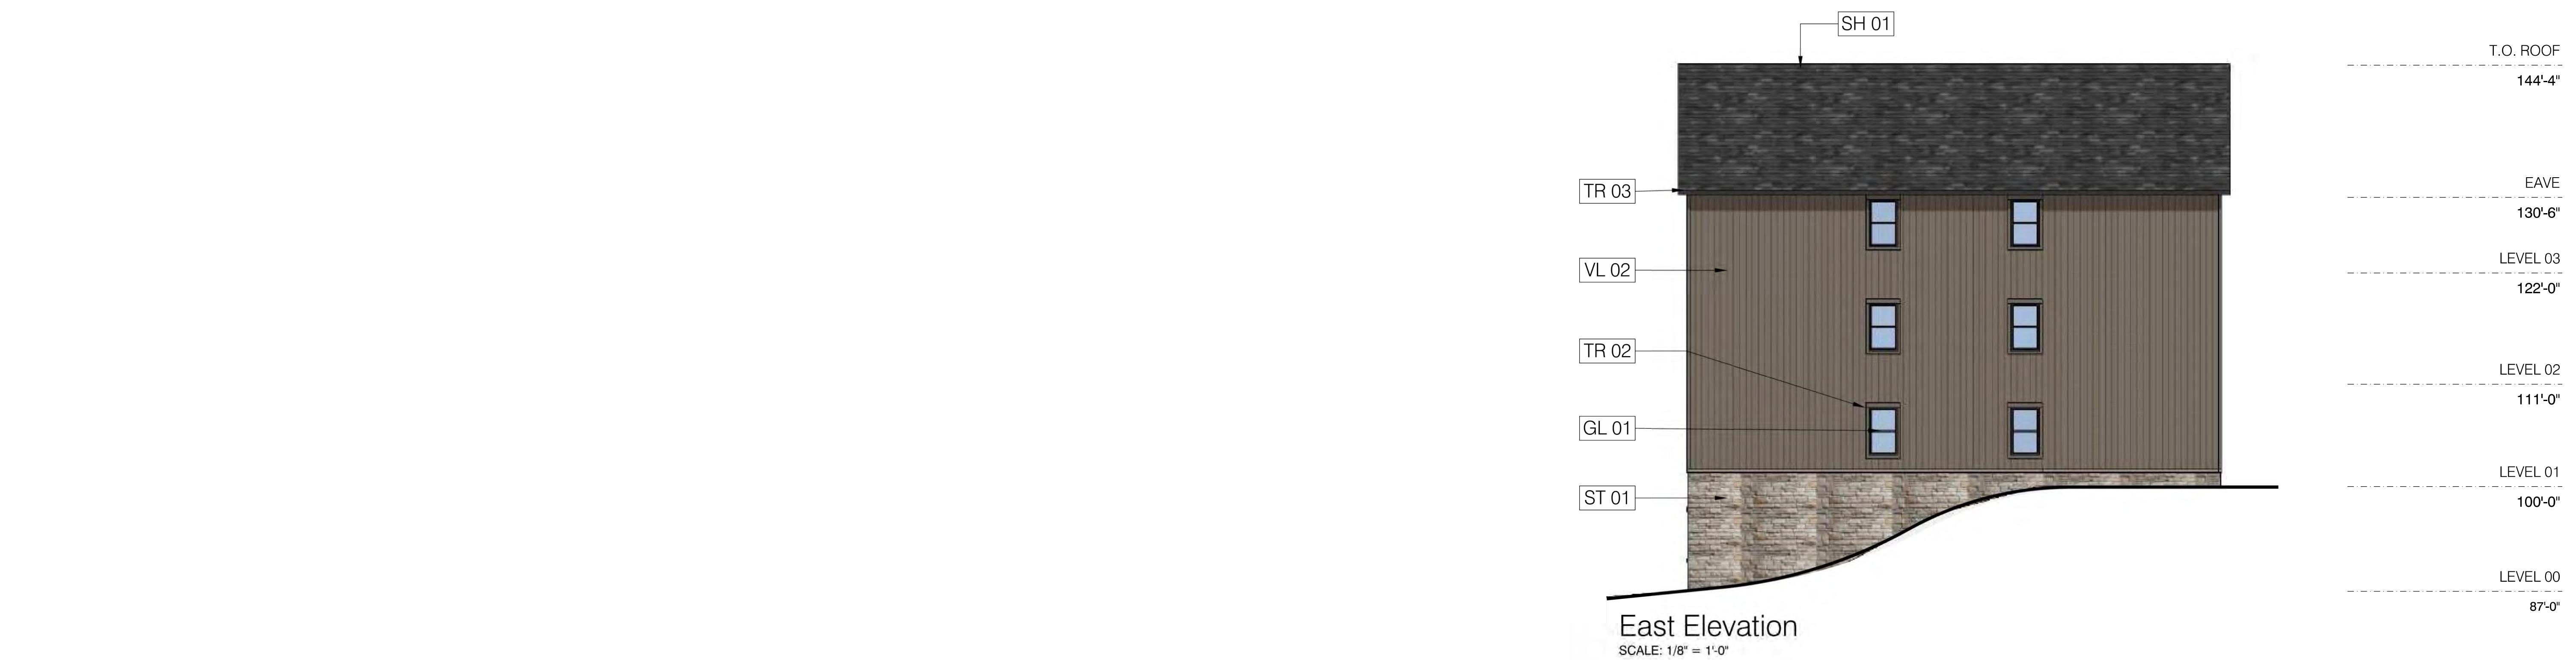


Building Type C // 10,400 SF  
 # Buildings // 04  
 # Levels // 03 / 04 Split  
 Units / BLDG // 42

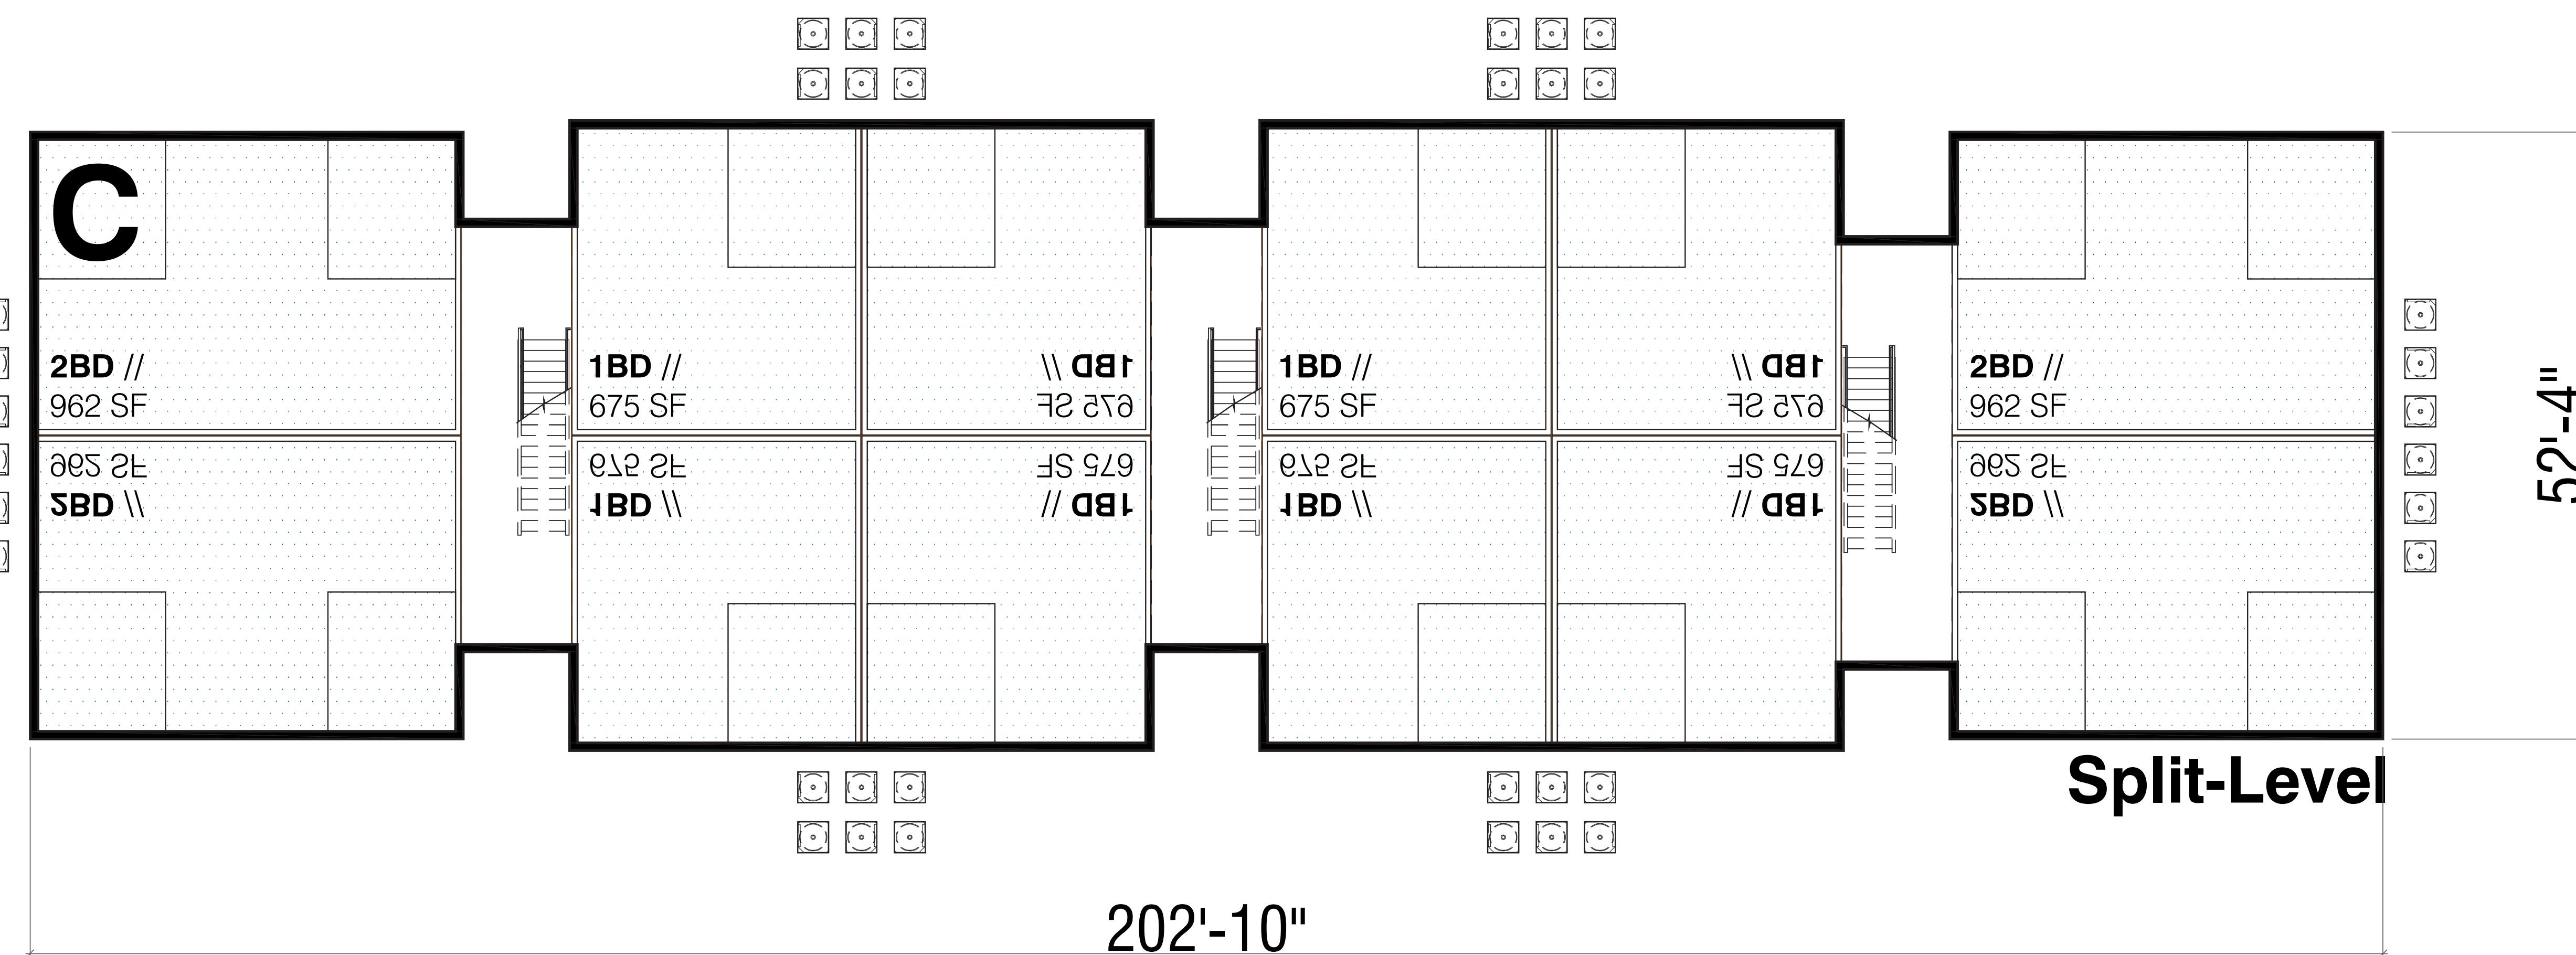







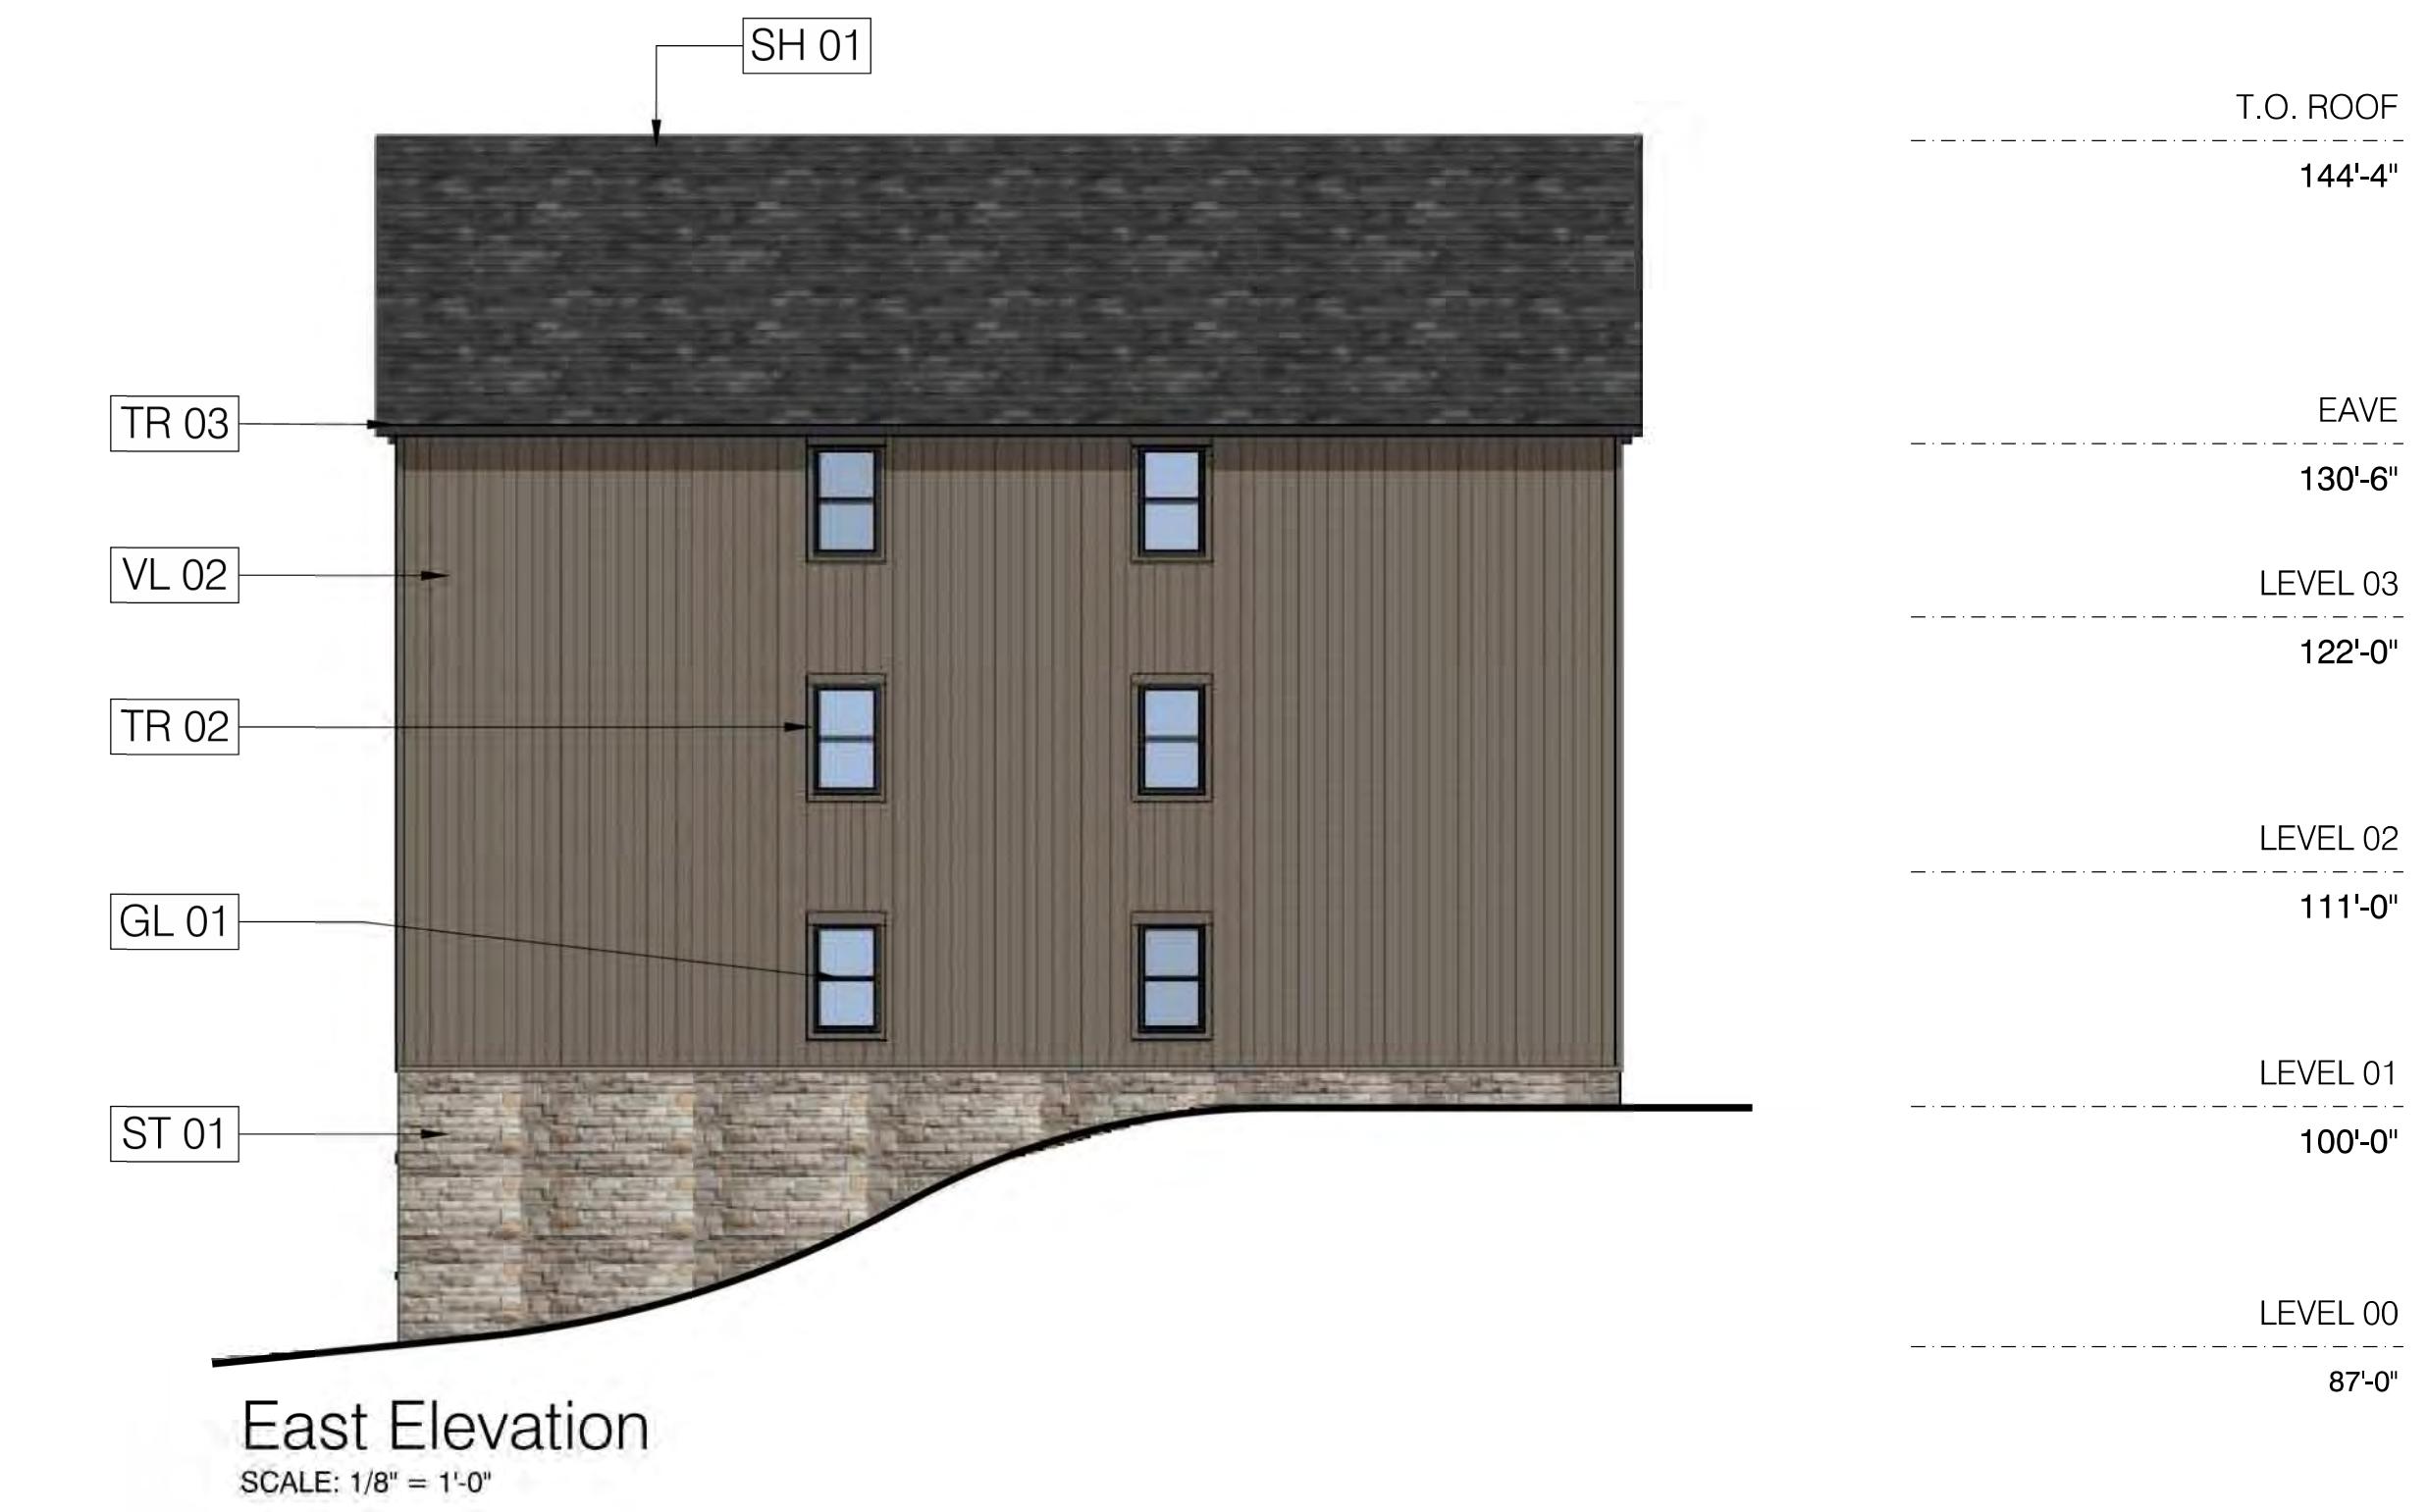

**ST 01**


MATERIAL  
PRODUCT  
COLOR  
INSTALL

STONE  
PROVIA  
OTTAWA  
DRY STACK

**SH 01**

MATERIAL  
PRODUCT  
COLOR  
INSTALL

ASPHALT SHINGLE  
-  
DARK  
-

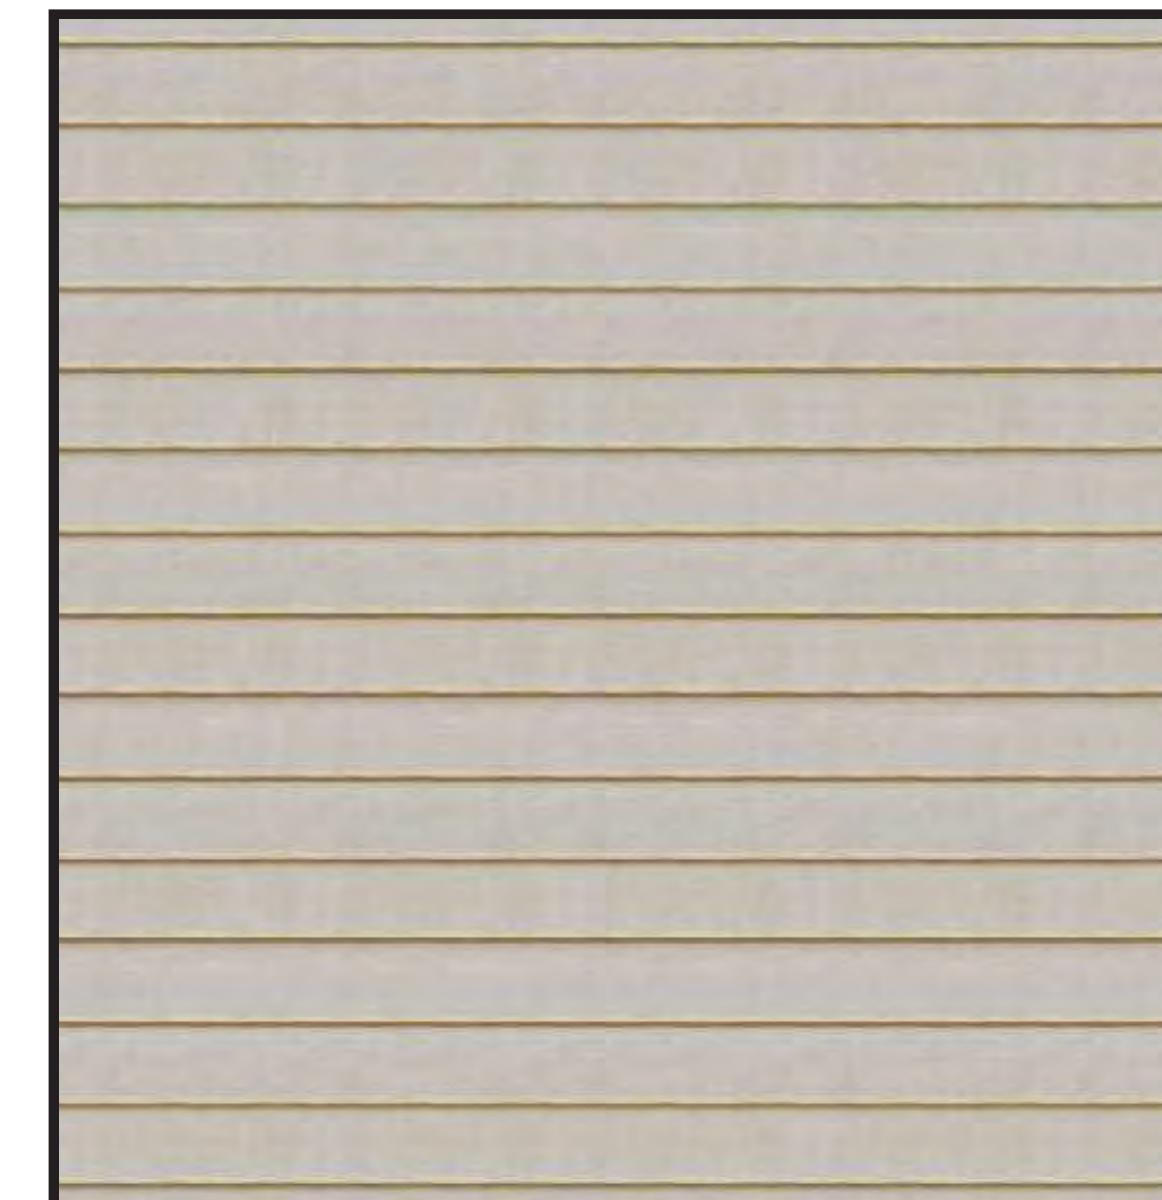**VL 01**


MATERIAL  
PRODUCT  
COLOR  
INSTALL

VINYL  
-  
LIGHT BROWN  
HORIZONTAL LAP

**VL 02**


MATERIAL  
PRODUCT  
COLOR  
INSTALL

VINYL  
-  
DARK BROWN  
BOARD & BATTEN

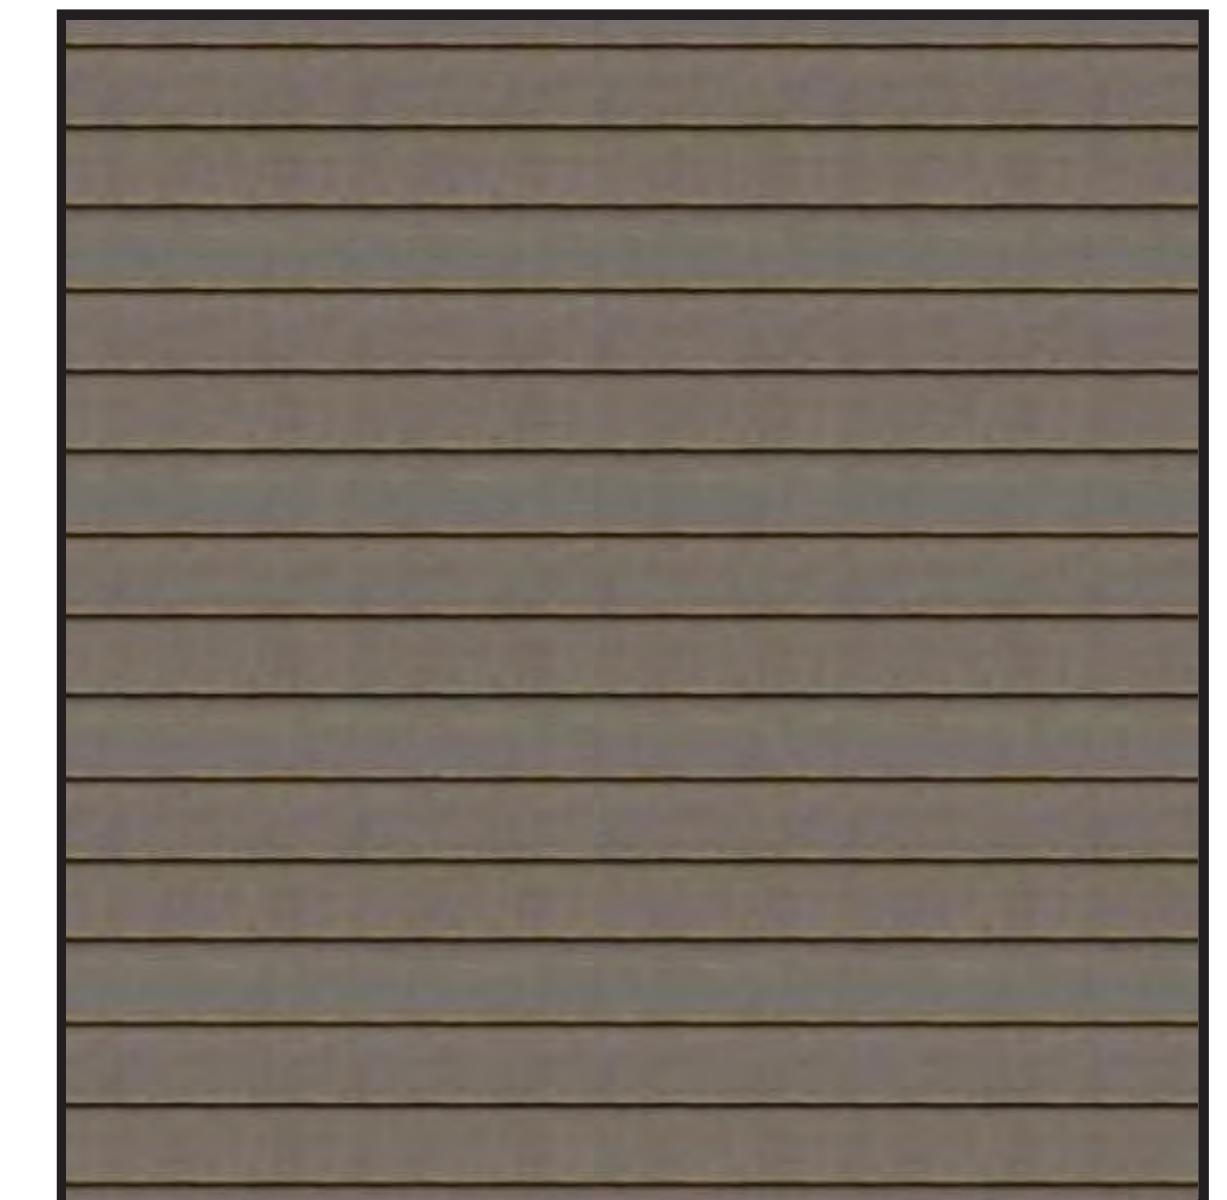**VL 03**


MATERIAL  
PRODUCT  
COLOR  
INSTALL

VINYL  
-  
DARK BROWN  
HORIZONTAL LAP

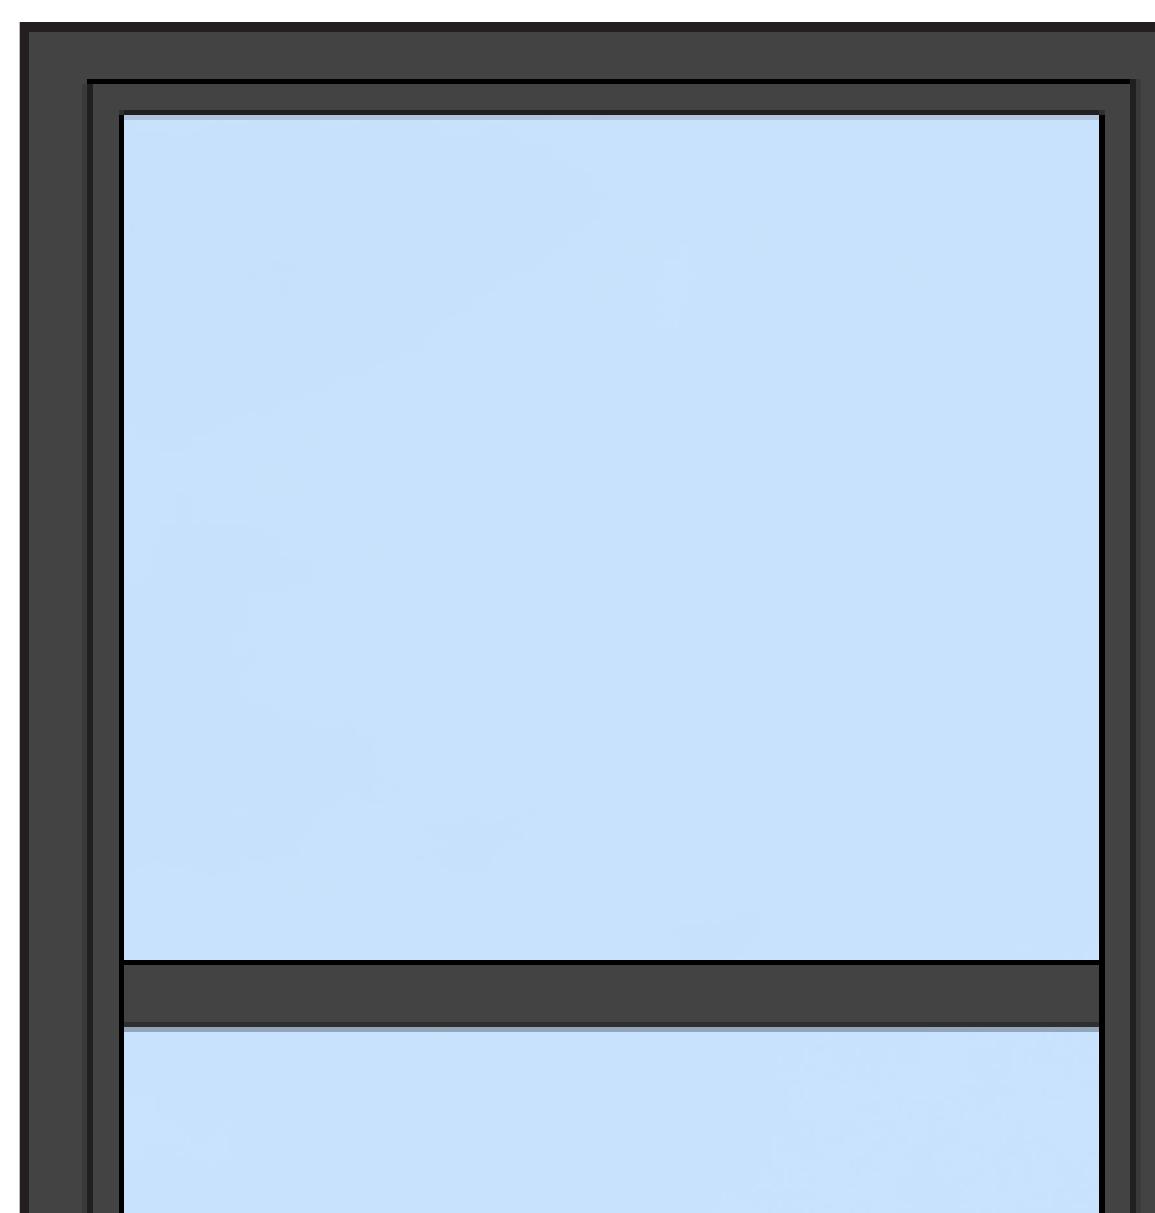**GL 01**


MATERIAL  
PRODUCT  
COLOR  
INSTALL

VINYL  
-  
DARK  
SINGLE-HUNG (OPERABLE)

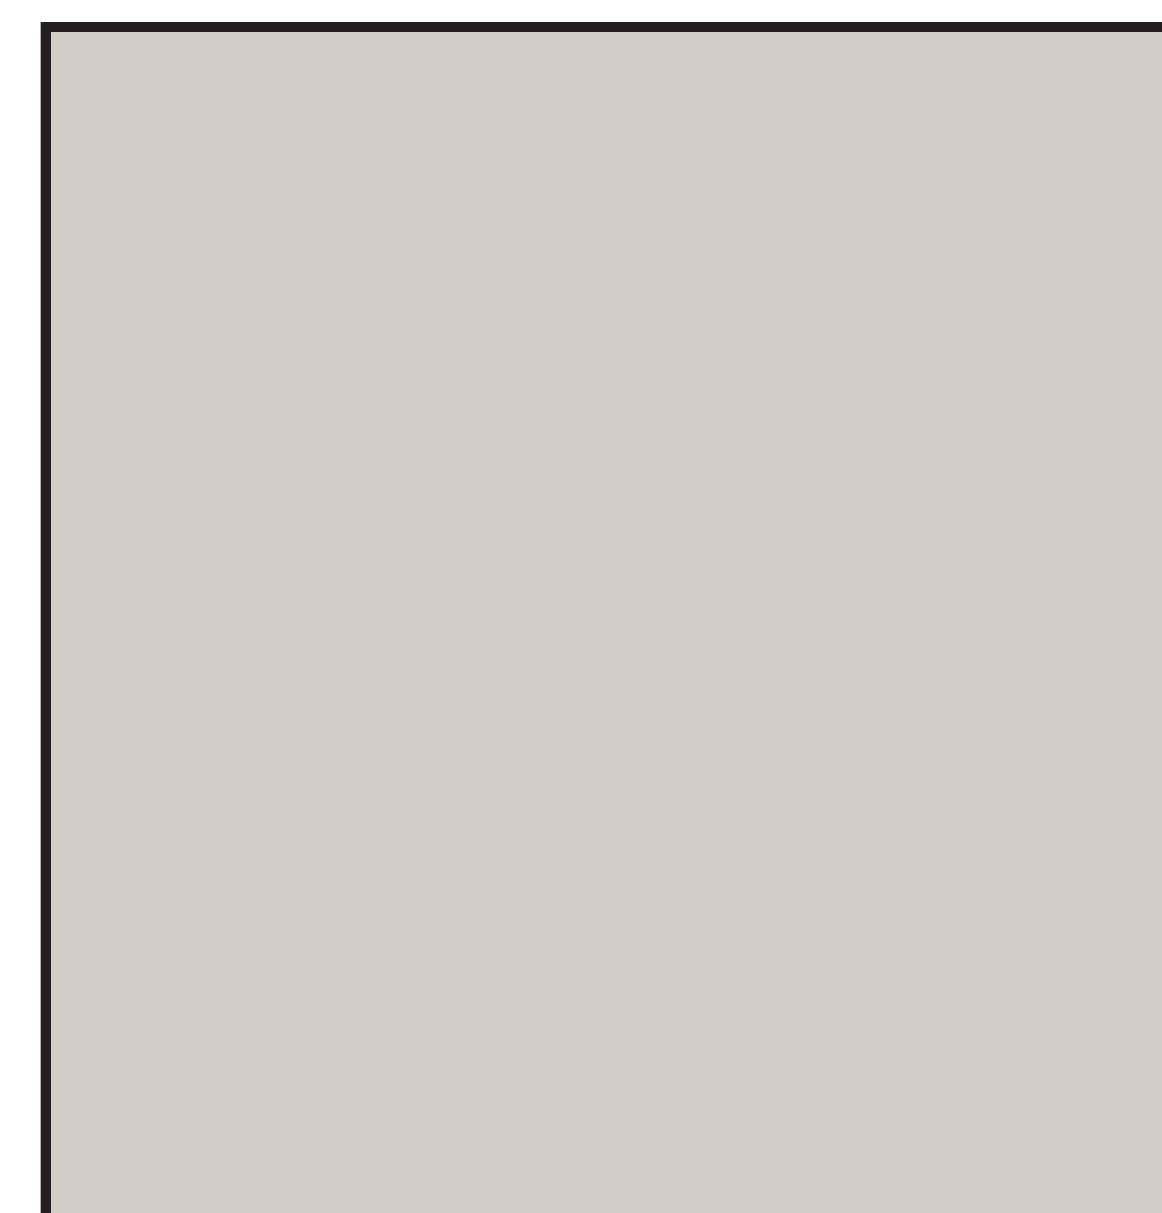**TR 01**


MATERIAL  
PRODUCT  
COLOR  
INSTALL

VINYL  
-  
LIGHT BROWN  
TRIM

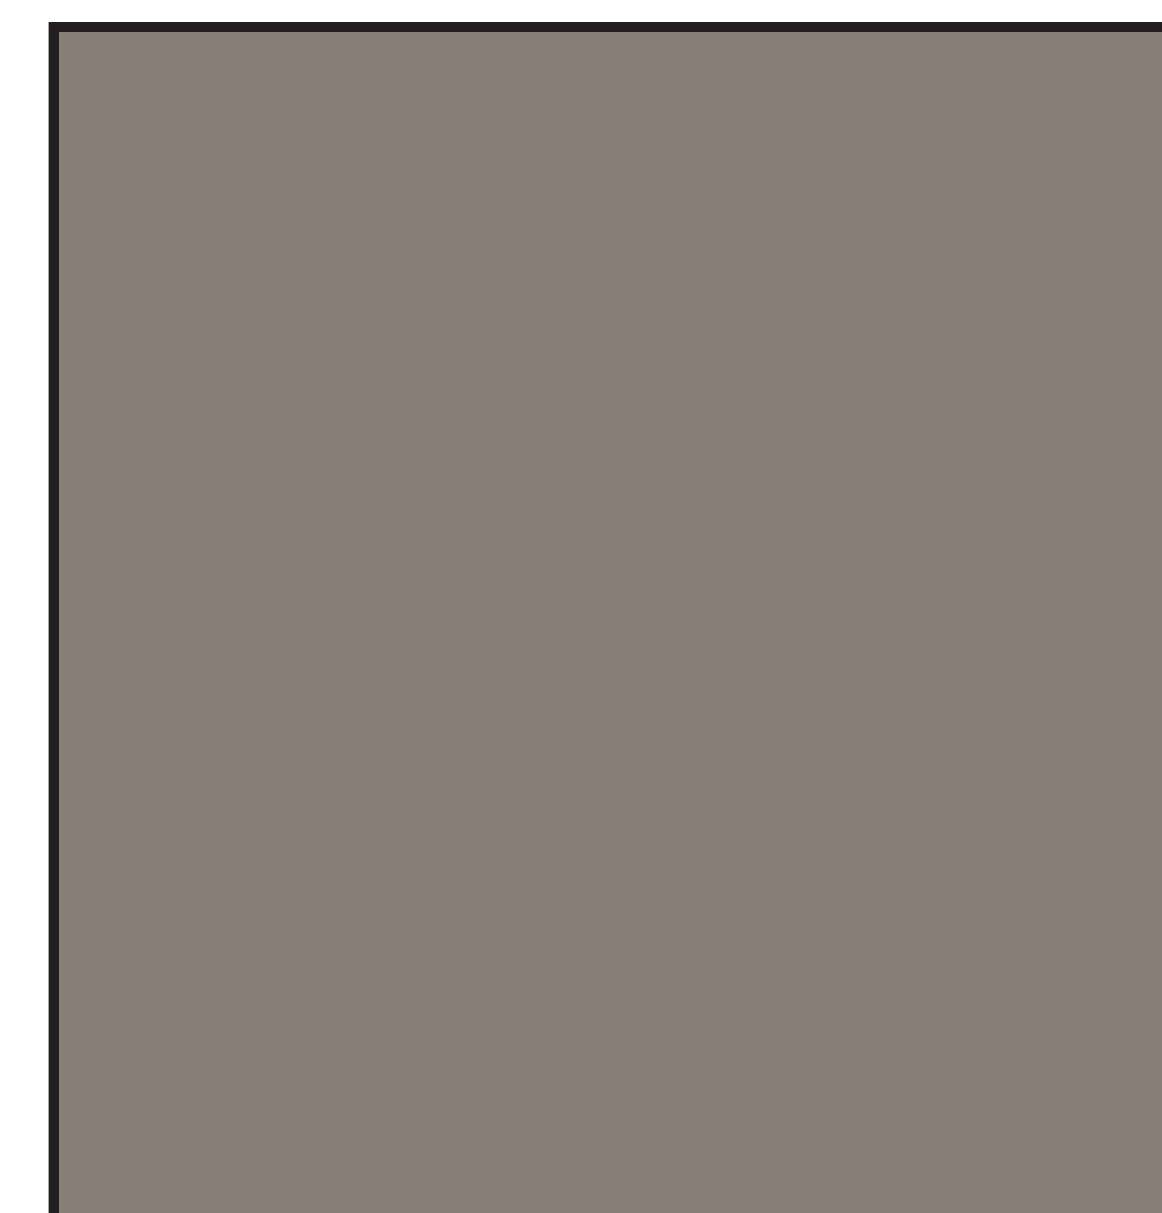**TR 02**

MATERIAL  
PRODUCT  
COLOR  
INSTALL

VINYL  
-  
DARK BROWN  
TRIM

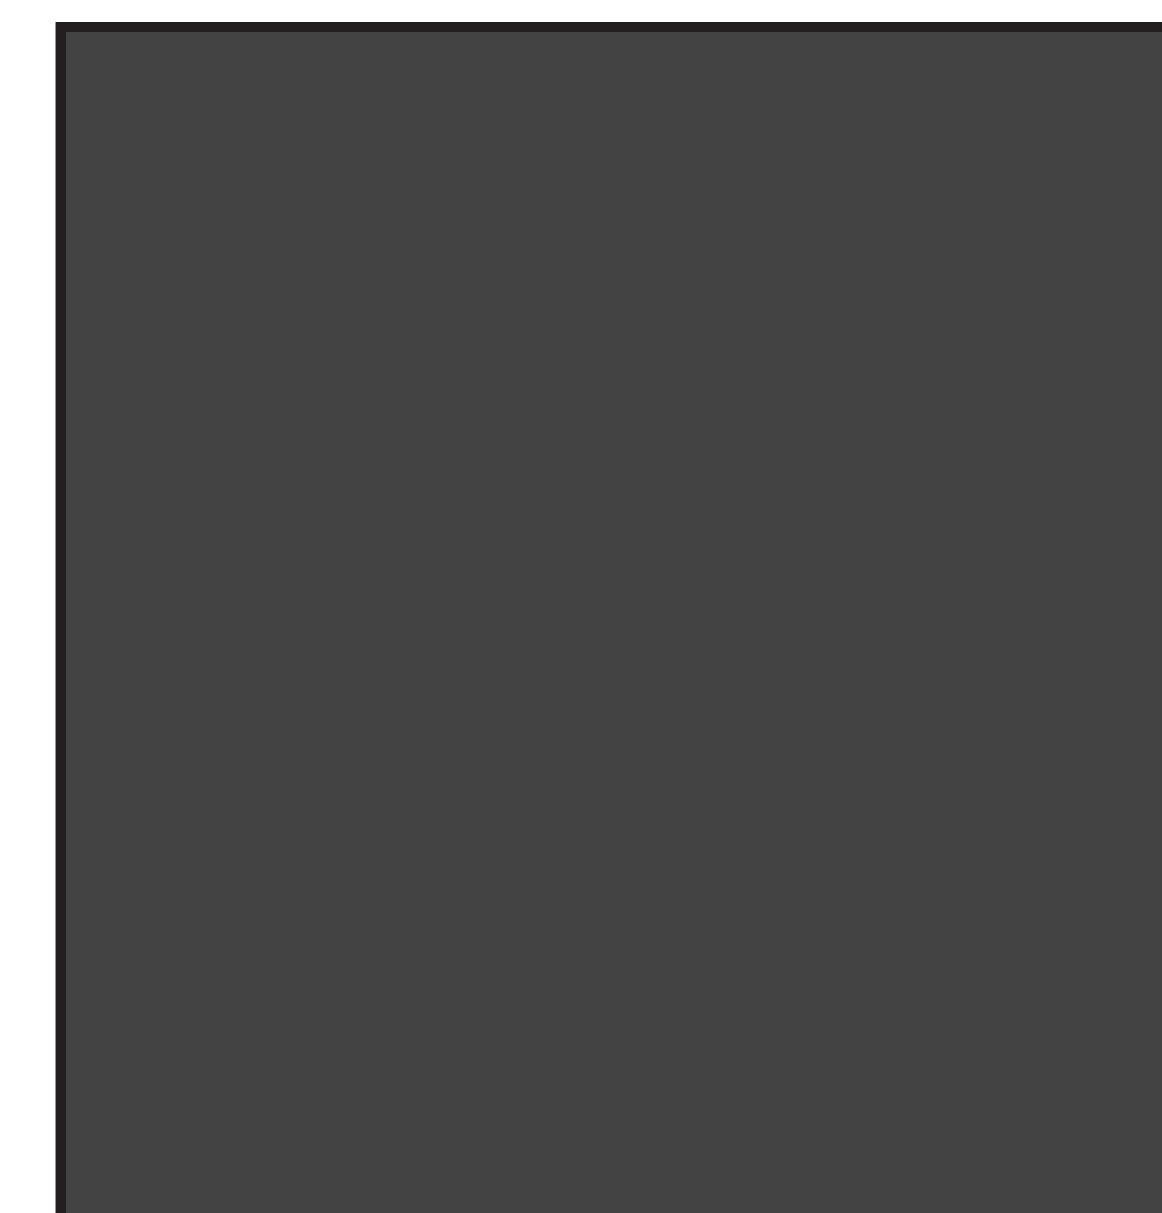**TR 03**

MATERIAL  
PRODUCT  
COLOR  
INSTALL

VINYL  
-  
DARK  
ROOF TRIM